
CENTENNIAL & HAMMOND HIGH SCHOOLS DOMESTIC WATER HEATER AND KITCHEN MAKE-UP AIR UNIT REPLACEMENTS

Centennial High School

4300 Centennial Lane Ellicott City, MD 21042

Hammond High School

8800 Guilford Road Columbia, MD 21046

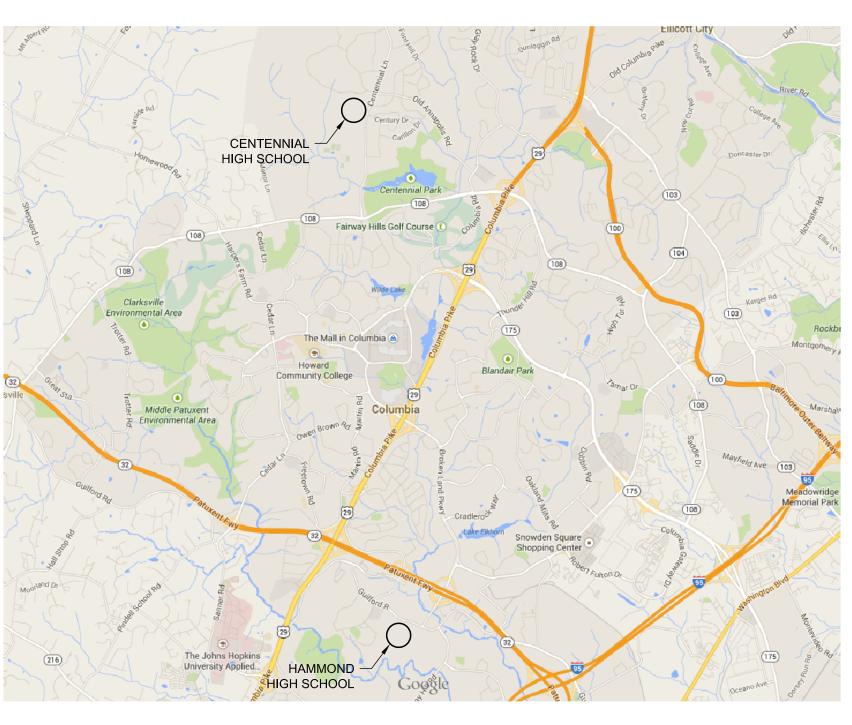

Vicinity Map

Construction Documents July 14, 2014

Owner

Howard County Public School System 8045 Harriet Tubman Lane Columbia, MD 21044

Drawing List

<u>GENERAL</u>		ELECTRIC	<u>CAL</u>
CS-1	COVER SHEET	E-1	CHS DOMESTIC HOT WATER ELECTRI AND NEW WORK PLANS
PLUMBING		E-2	HHS DOMESTIC HOT WATER ELECTRICAND NEW WORK PLANS
P-1	CHS DOMESTIC HOT WATER PLUMBING DEMOLITION AND NEW WORK PLANS	E-3	KITCHEN MAKE-UP AIR UNIT DEMOLIT WORK PLANS
P-2	HHS DOMESTIC HOT WATER PLUMBING DEMOLITION AND NEW WORK PLANS	STRUCTU	JRAL_
P-3	DOMESTIC HOT WATER SCHEMATIC DIAGRAM, DETAILS, AND SCHEDULES	S-1	CHS/HHS PARTIAL ROOF PLANS, GEN

KITCHEN MAKE-UP AIR UNIT DEMOLITION AND NEW WORK PLANS, DETAILS, AND SCHEDULES

RICAL DEMOLITION RICAL DEMOLITION ITION AND NEW

CHS/HHS PARTIAL ROOF PLANS, GENERAL NOTES, AND **DETAILS**

MEP Engineer

Green Building Energy Engineers, LLC 8029 Somerville Lane Elkridge, Maryland 21075 (410) 799-1080

Structural Engineer

Columbia Engineering, Inc. 6210 Old Dobbin Lane, Suite 150 Columbia, MD 21045 (410) 992-9970

SUBCONSULTANT

Columbia Engineering, Inc. 6210 Old Dobbin Lane, Suite 150 Columbia, MD 21045

SEAL

Howard County Public School System 8045 Harriet Tubman Lane Columbia, MD 21044


PROJECT

KEY PLAN

NO. DESCRIPTION

COVER SHEET

DRAWN BY CHECKED BY PROJECT NO. NONE

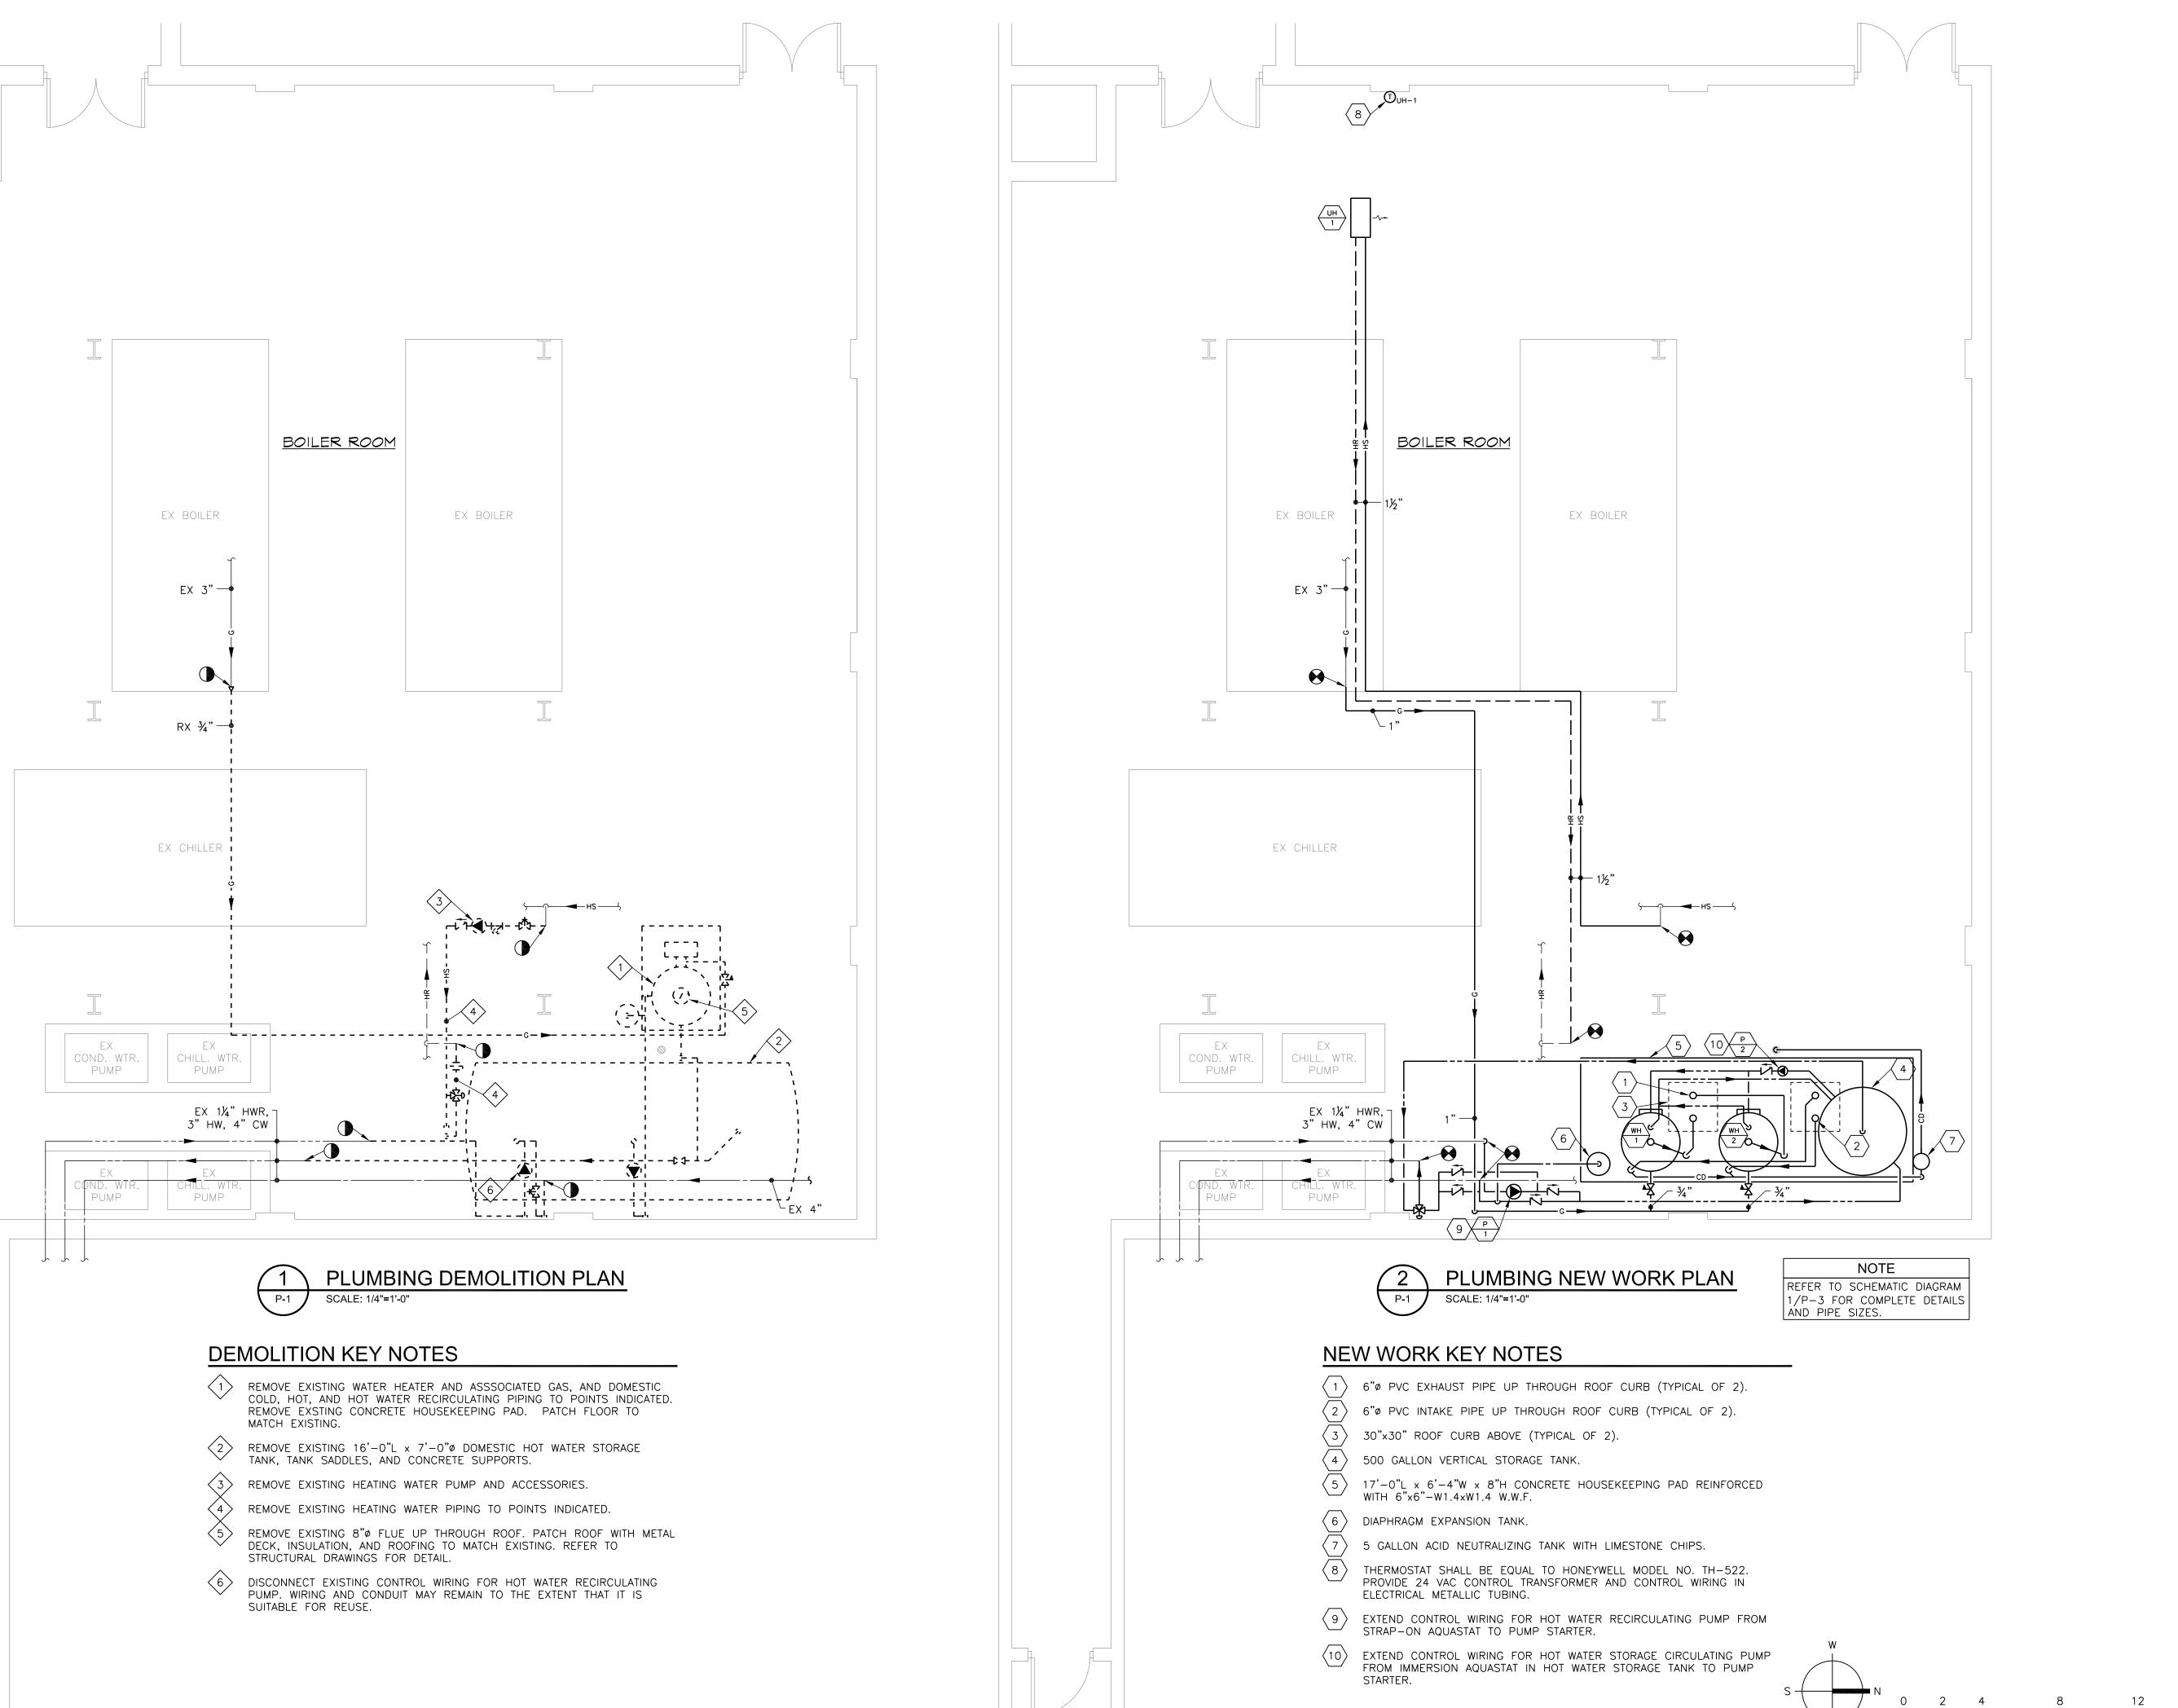

GBEE

GREEN BUILDING ENERGY ENGINEERS, LLC

SUBCONSULTANT

Columbia Engineering, Inc. 6210 Old Dobbin Lane, Suite 150 Columbia, MD 21045

It is a blessing to work with you. www.GreenBuildingEnergyEngineers.com

SEAL

Professional Certification. I certify that these documents were prepared or approved by me, and that I am a duly licensed engineer under the laws of the State of Maryland, License Number 20533, expiration date 8/5/2016.

OWNER

Howard County Public School System 8045 Harriet Tubman Lane Columbia, MD 21044

PROJECT

High School 8800 Guilford Road Columbia, MD 21046

HEATER AND
NIT REPLACEMI

ial High School Lane 1042

KEY PLAN

AREA OF WORK

01	CONSTRUCTION DOCUMENTS	07/14/14
N O.	DESCRIPTION	DATE


DRAWING

SCALE: 1/4"=1'-0"

CHS DOMESTIC HOT WATER PLUMBING DEMOLITION AND NEW WORK PLANS

•	DRAWN BY	WLA
8	CHECKED BY	WLA
	PROJECT NO.	14014
	SCALE	as shown
•	eucet	

P-1

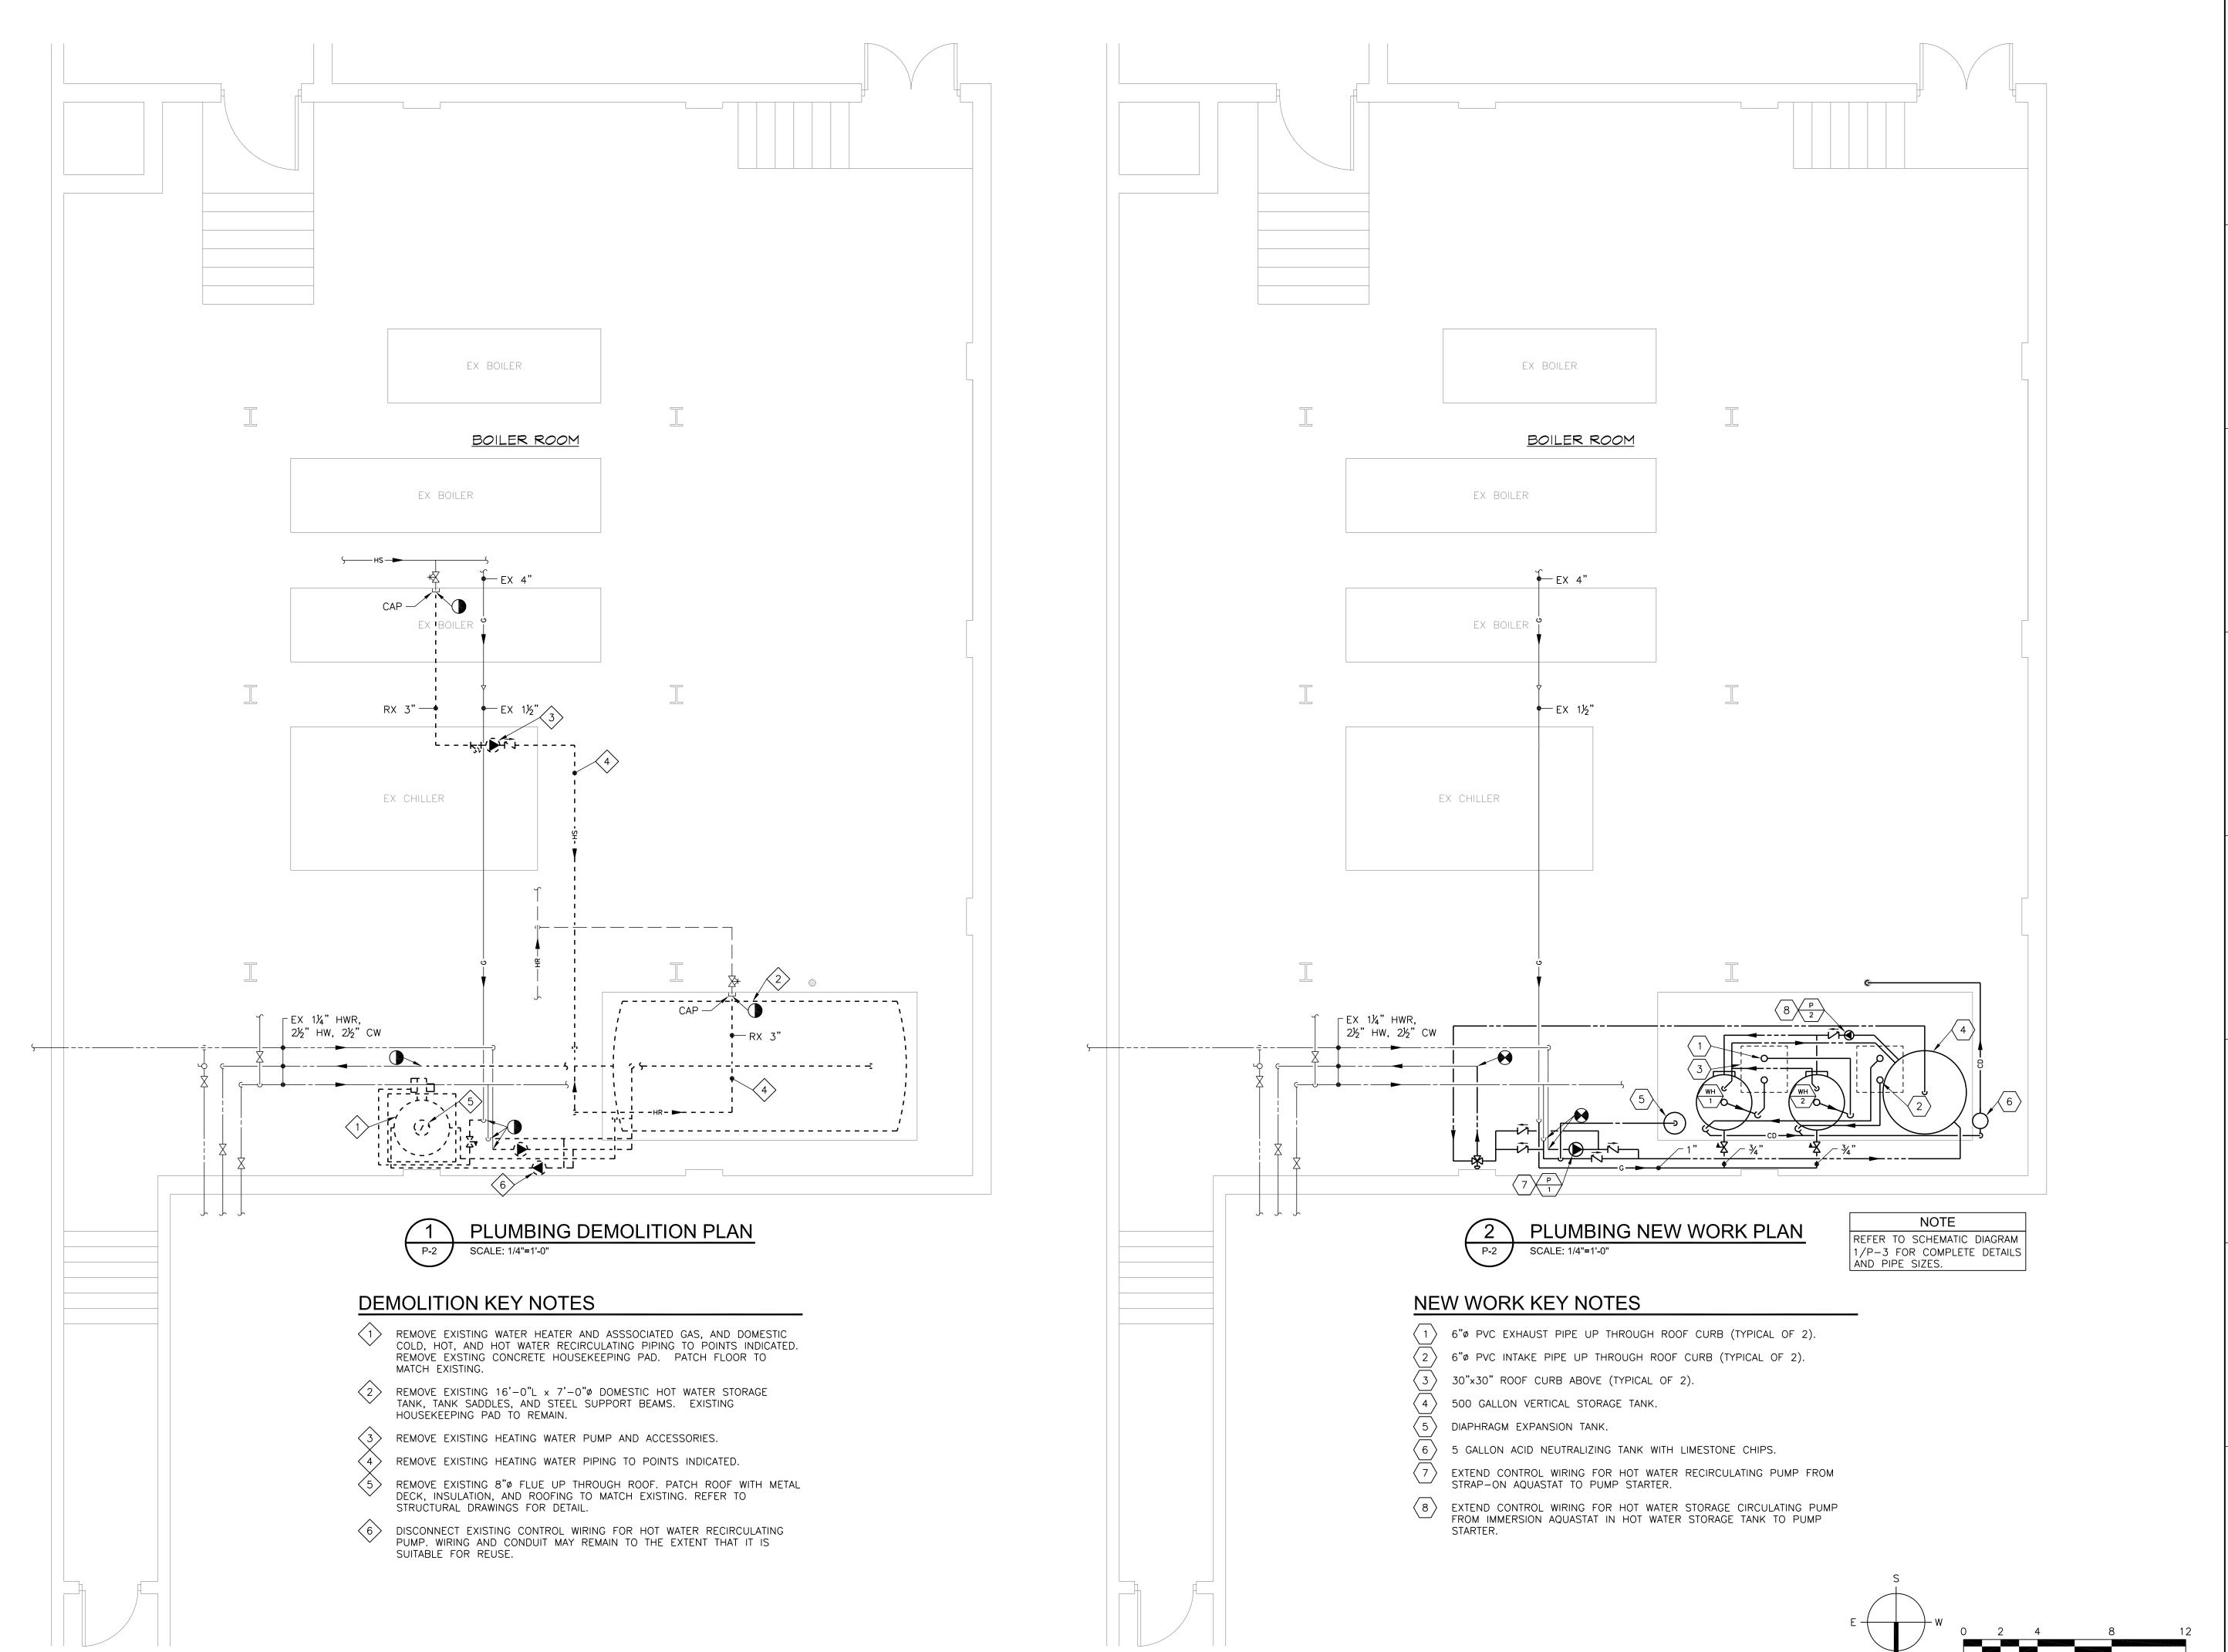



GREEN BUILDING ENERGY ENGINEERS, LLC

 MECHANICAL - ELECTRICAL - PLUMBING

 8029 Somerville Lane
 TEL: 410-799-1080

 Elkridge, MD 21075
 FAX: 410-799-1081

It is a blessing to work with you. www.GreenBuildingEnergyEngineers.com

SUBCONSULTANT

Columbia Engineering, Inc. 6210 Old Dobbin Lane, Suite 150 Columbia, MD 21045

SEAL

Professional Certification. I certify that these documents were prepared or approved by me, and that I am a duly licensed engineer under the laws of the State of Maryland, License

Number 20533, expiration date 8/5/2016.

OWNER


Howard County Public School System 8045 Harriet Tubman Lane Columbia, MD 21044

PROJECT

High School

ATER HEATER AND
AIR UNIT REPLACEM
Hammond High

nial High School ial Lane D 21042

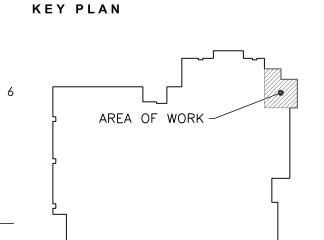

N O.	DESCRIPTION	DATE
01	CONSTRUCTION DOCUMENTS	07/14/14


DRAWING

SCALE: 1/4"=1'-0"

HHS DOMESTIC HOT WATER PLUMBING DEMOLITION AND NEW WORK PLANS

	DRAWN BY	WLA
8	CHECKED BY	WLA
	PROJECT NO.	14014
	SCALE	as shown
	SHEET	

P-2

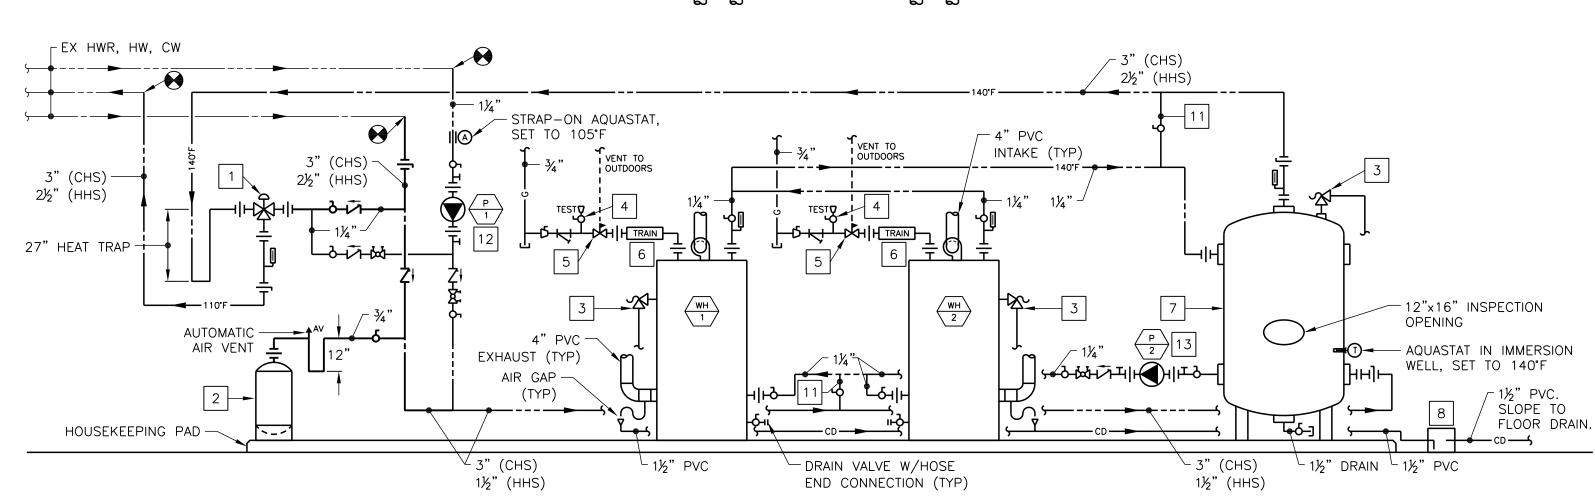

1 DOMESTIC HOT WATER SCHEMATIC DIAGRAM P-3 NO SCALE

KEY NOTES

ALL BRONZE CONSTRUCTION.

PROVIDE FACTORY-INSTALLED OSHA FAN GUARD.

FIELD INSTALL FACTORY-FURNISHED UNFUSED DISCONNECT SWITCH.

- 1 THERMOSTATIC MIXING VALVE, EQUAL TO LAWLER MODEL 802.
- 2 150 PSI ASME RATED DIAPHRAGM EXPANSION TANK, EQUAL TO BELL & GOSSETT MODEL NO. PTA-42V.
- 3 COMBINATION TEMPERATURE AND PRESSURE RELIEF VALVE. EXTEND DISCHARGE FULL SIZE TO FLOOR DRAIN.
- 4 BALL VALVE AND PLUG.
- LINE PRESSURE REGULATOR, 10 PSIG TO 9" W.C., EQUAL TO MAXITROL 210D. PROVIDE VENT PIPING TO A POINT OUTDOORS AND TERMINATE WITH RAIN CAP.
- 6 CSD-1 GAS TRAIN FURNISHED WITH WATER HEATER.
- 500 GALLON VERTICAL STORAGE TANK, ASME 150 PSI RATED, GLASS-LINED, EQUAL TO A.O. SMITH MODEL NO. TJV-500. TANK SHALL HAVE (4)-3", (1)-1", AND (1)-34" SIDE TAPPINGS, (2)-3" TOP TAPPINGS, 1½" DRAIN, (2)-2" ANODE TAPPINGS, AND (1)-12"x16" INSPECTION OPENING.


KEY NOTES (CONT.)

- 8 5 GALLON ACID NEUTRALIZING TANK, EQUAL TO AXIOM INDUSTRIES MODEL NO. NT20, WITH LIMESTONE CHIPS.
- 4" PVC INTAKE PIPES THROUGH ROOF. ROUTE PIPING THROUGH 30"x30" ROOF CURB WITH PIPING BOOTS. PROVIDE FLASHING AND PATCH ROOF TO MAINTAIN WARRANTY. TERMINATE PIPES 18" ABOVE TOP OF ROOF CURB WITH 45° ELBOWS AND BIRD SCREENS OVER OPENINGS.
- 4" PVC EXHAUST PIPES THROUGH ROOF. ROUTE PIPING THROUGH 30"x30" ROOF CURB WITH PIPING BOOTS. PROVIDE FLASHING AND PATCH ROOF TO MAINTAIN WARRANTY. TERMINATE PIPES 18" ABOVE TOP OF ROOF CURB WITH 45° ELBOWS AND BIRD SCREENS OVER OPENINGS.
- 11 11/4" BYPASS PIPE WITH BALL VALVE.
- OPERATION OF PUMP P-1 SHALL BE CONTROLLED BY STRAP-ON AQUASTAT ON HOT WATER RECIRCULATING PIPE.
- OPERATION OF PUMP P-2 SHALL BE CONTROLLED BY IMMERSION AQUASTAT IN HOT WATER STORAGE TANK.

GAS-	GAS-FIRED WATER HEATER SCHEDULE												
		RECC)VERY		T								
DESIG.	STORAGE (GAL.)	GPH	TEMP. RISE (°F)	INPUT (BTUH)	THERMAL EFFICIENCY	INTAKE (DIA.)	VENT (DIA.)	ELEC. (VOLT./PH)	BASIS OF DESIGN	NOTES			
WH-1	130	466	100	399,900	96%	4"	4"	120/1	A.O. SMITH BTH-400A	1			
WH-2	130	466	100	399,900	96%	4"	4"	120/1	A.O. SMITH BTH-400A	1			
NOTES:													
1. ASME T	ANK.												

PUM	P SCHEDULE										
DESIG.	SERVICE	TYPE	FLUID	FLOW (GPM)	HEAD (FT W.C.)	SPEED (RPM)	IMPELLER DIA (IN.)	MOTOR (HP)	ELEC. (VOLT./PH)	BASIS OF DESIGN	NOTES
P-1	HOT WATER RECIRC.	IN-LINE	WATER	20	45	1,750	6.50	1.5	480/3	BELL & GOSSETT 60-STOCK-617	1
P-2	STORAGE CIRCULATOR	IN-LINE	WATER	20	10	3,300	2.00	1/6	120/1	BELL & GOSSETT BOOSTER PL-50	1
NOTES:											

HOT '	WATER UNIT HEA	ATER SO	CHEDUL	.E						
DESIG.	SERVICE	TYPE	CAPACITY (BTUH)*	FLOW (GPM)	WPD (FT W.C.)	AIRFLOW (CFM)	MOTOR (HP)	ELEC. (VOLT./PH)	BASIS OF DESIGN	NOTES
UH-1	BOILER ROOM	VERTICAL	205,400	20.0	2.68	4,200	1/2	480/3	TRANE MODEL NO. UHP-280-6-T-A-1-1	1,2

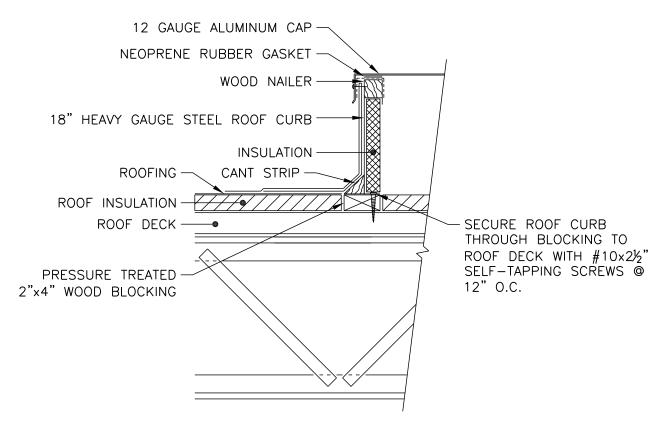


P-3 ROOF CURB DETAIL


NO SCALE

NOTE

- 1. PROVIDE ALL FLASHING, PATCHING, AND SEALANT AS REQUIRED FOR A WATER TIGHT INSTALLATION.
- ALL ROOFING WORK SHALL BE PERFORMED IN ACCORDANCE WITH THE EXISTING ROOFING WARRANTY.

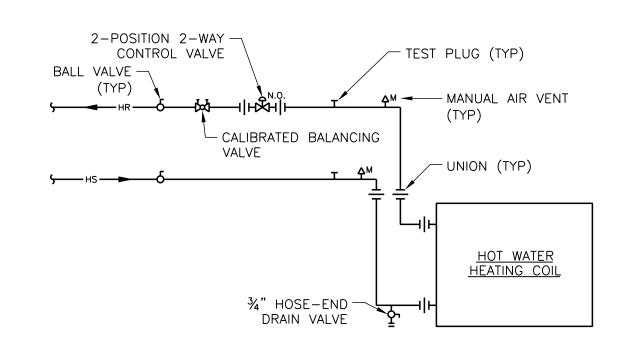

3 UNIT HEATER COIL CONNECTION DETAIL
P-3 NO SCALE

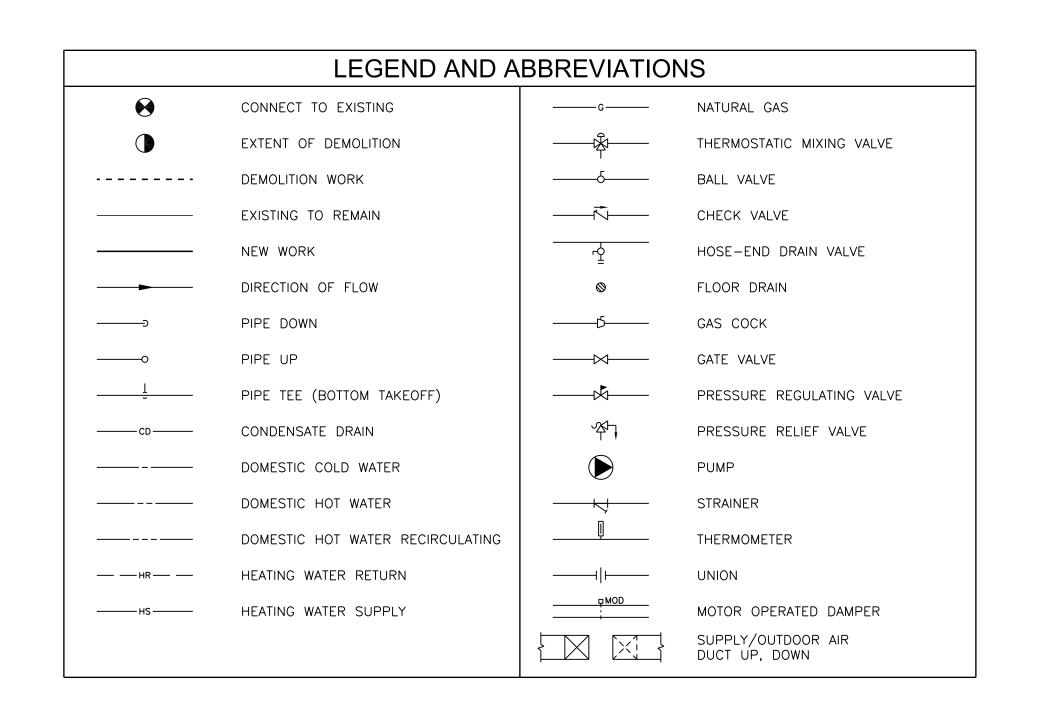



GREEN BUILDING ENERGY ENGINEERS, LLC
MECHANICAL - ELECTRICAL - PLUMBING

FAX: 410-799-1081

It is a blessing to work with you. www.GreenBuildingEnergyEngineers.com

SUBCONSULTANT

Columbia Engineering, Inc. 6210 Old Dobbin Lane, Suite 150 Columbia, MD 21045

SEAL

Professional Certification. I certify that these documents were prepared or approved by me, and that I am a duly licensed engineer under the laws of the State of Maryland, License Number 20533, expiration date 8/5/2016.

OWNER

Howard County Public School System 8045 Harriet Tubman Lane Columbia, MD 21044

PROJECT

R AND
LACEMENTS

and High School

& HAMMOND HIGH
IC WATER HEATER
E-UP AIR UNIT REPL
chool Hammon

ENTENNIAL & H
DOMESTIC V
CHEN MAKE-UF

KEY PLAN

01 CONSTRUCTION DOCUMENTS 07/14/14


NO. DESCRIPTION DATE

DRAWING

DOMESTIC HOT WATER SCHEMATIC DIAGRAM, DETAILS, AND SCHEDULES

	DRAWN BY	WLA
8	CHECKED BY	WLA
	PROJECT NO.	14014
	SCALE	NONE
'	SHEET	




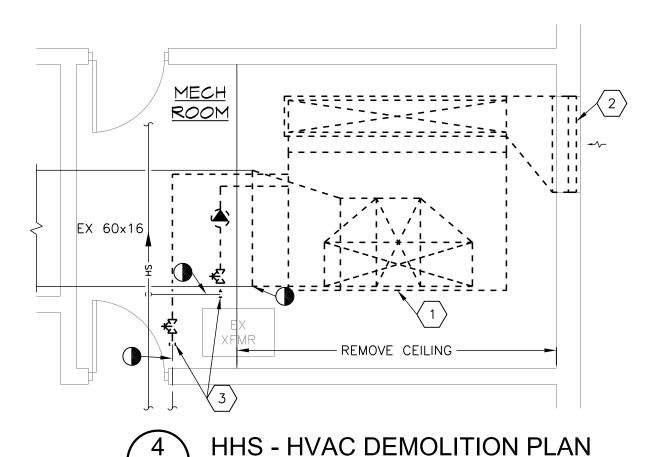


DEMOLITION KEY NOTES

SCALE: 1/4"=1'-0"

- REMOVE EXISTING AIR HANDLING UNIT, SUPPLY AND OUTDOOR AIR DUCTWORK, HEATING WATER PUMP, HEATING WATER SUPPLY AND RETURN PIPING, AND SHUTOFF VALVES TO POINTS INDICATED.
- REMOVE EXISTING 48"x48" OUTDOOR AIR LOUVER AND STORE FOR REINSTALLATION.
- REMOVE EXISTING VERTICAL PIPING TO A POINT 9'-4" ABOVE FINISHED

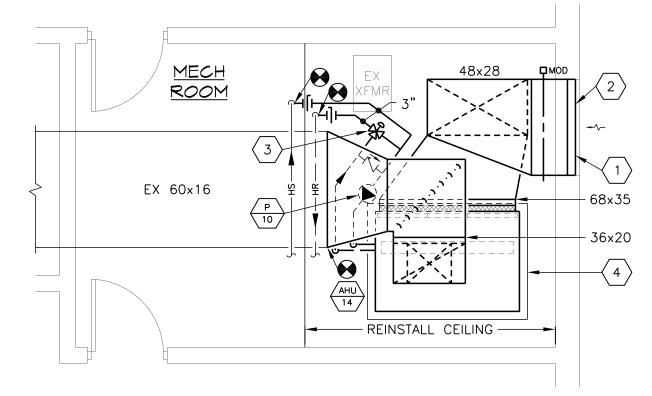



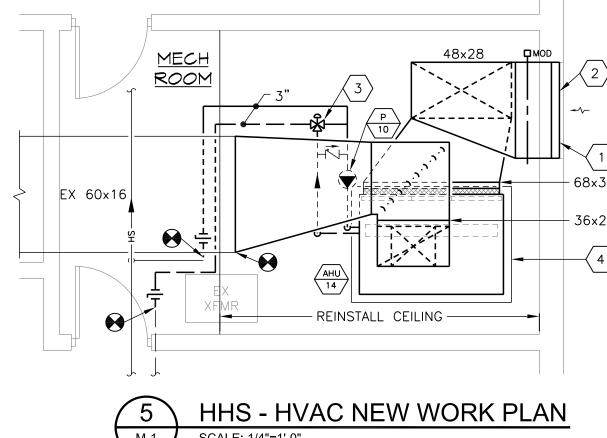


NEW WORK KEY NOTES


- RIG REPLACEMENT AIR HANDLING UNIT IN SECTIONS THROUGH EXISTING OUTDOOR AIR LOUVER OPENING IN WALL.

- MOUNT AIR HANDLING UNIT ON 4" HOUSEKEEPING PAD.

ADD ALTERNATE PRICING

1. THE PRICE FOR ALL WORK ASSOCIATED WITH THE REPLACEMENT OF THE KITCHEN MAKE-UP AIR UNIT FOR EACH SCHOOL SHOWN ON DRAWINGS M-1 AND E-3 SHALL BE IDENTIFIED ON THE BID FORM AS THE ADD ALTERNATE NO. 1 PRICE FOR EACH SCHOOL.

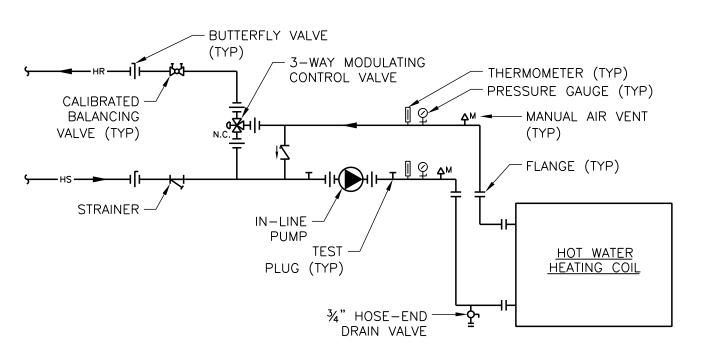

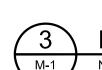

HEATING WATER COIL CONNECTION DETAIL

ARRANGE COIL PIPING CONNECTIONS TO FACILITATE REMOVAL OF COIL FROM EQUIPMENT WITH A MINIMUM DISTURBANCE TO PIPING.

ATC DEMOLITION WORK

- DISCONNECT ALL EXISTING AUTOMATIC TEMPERATURE CONTROLS (ATC) COMPONENTS ASSOCIATED WITH AIR HANDLING UNIT AHU-14 AND HEATING WATER PUMP P-10. EXISTING ATC COMPONENTS INCLUDE:
- AHU-14 SUPPLY FAN START/STOP.
- 3-WAY MODULATING CONTROL VALVE. LOW LIMIT TEMPERATURE SENSOR.
- OUTDOOR AIR DAMPER OPEN/CLOSE. PUMP P-10 START/STOP.
- 2. REMOVE EXISTING OUTDOOR AIR MOTOR OPERATED DAMPER ACTUATOR AND HEATING WATER CONTROL VALVE ACTUATOR.
- 3. EXISTING ATC WIRING AND PNEUMATIC TUBING SHALL REMAIN FOR CONNECTION TO REPLACEMENT AIR HANDLING UNIT AND HEATING WATER

ATC NEW WORK

- 1. PROVIDE NEW OUTDOOR AIR MOTOR OPERATED DAMPER ACTUATOR AND HEATING WATER CONTROL VALVE ACTUATOR.
- 2. RECONNECT ALL AUTOMATIC TEMPERATURE CONTROLS (ATC) COMPONENTS ASSOCIATED WITH AIR HANDLING UNIT AHU-14 AND HEATING WATER PUMP P-10. ATC COMPONENTS INCLUDE:
- A. AHU-14 SUPPLY FAN START/STOP.
 - 3-WAY MODULATING CONTROL VALVE.
- LOW LIMIT TEMPERATURE SENSOR. D. OUTDOOR AIR DAMPER OPEN/CLOSE.
- E. PUMP P-10 START/STOP.
- 3. RECONNECT ALL ATC WIRING AND PNEUMATIC ASSOCIATED WITH AIR HANDLING UNIT AND HEATING WATER PUMP.
- 4. PROVIDE ALL NECESSARY ATC COMPONENTS, WIRING, AND CONDUIT TO INTERLOCK THE OPERATION OF AHU-14 WITH THE EXISTING KITCHEN RANGE HOOD EXHAUST FAN.
- 5. VERIFY PROPER OPERATION OF ALL ATC COMPONENTS.

SCALE: 1/4"=1'-0"

- REINSTALL EXISTING 48"x48" OUTDOOR AIR LOUVER. PROVIDE NEW PNEUMATIC ACTUATOR.
- PROVIDE NEW 3-WAY MODULATING CONTROL VALVE AND PNEUMATIC

PUMF	SCHEDULE									
DESIG.	SERVICE	TYPE	FLUID	FLOW (GPM)	HEAD (FT W.C.)	SPEED (RPM)	IMPELLER DIA (IN.)	MOTOR (HP)	ELEC. (VOLT./PH)	BASIS OF DESIGN
P-10	AHU-14 HEATING COIL	IN-LINE	WATER	86	27	1,750	5.25	1	480/3	BELL & GOSSETT 60-STOCK-612

AIR HANDLING UNIT SCHEDULE

			SUP	PPLY FAN								HOT W	ATER HEATIN								FILTERS						
DESIG.	SERVICE	SUPPLY AIR OUTE (CFM) (DOOR AIR (CFM)	ESP (IN. W.C.)	TSP (IN. W.C.)	MOTOR (HP)	AIRFLOW (CFM)	CAPACITY (MBH)	FACE VEL (FPM)	EAT (°F)	LAT (°F)	APD (IN. W.C.)	ROWS	FPI	FLUID	FLOW (GPM)	EWT (°F)	LWT (°F)	WPD (FT W.C.)	THICKNESS	TYPE	EFFICIENCY	(VOLT./PH)	DIMENSIONS (L x W x H)	WEIGHT (LBS)	BASIS OF DESIGN	NOTES
AHU-14	KITCHEN MAKE-UP AIR	8,400 8	8,400	1.00	2.04	7.5	8,400	861.8	672	0.0	95.0	0.36	2	12	WATER	86.2	180	160	4.1	2"	PLEATED	MERV 8	480/3	50" x 72" x 83"	1,445	TRANE CLIMATE CHANGER SIZE 14	1-5

UNIT SHALL HAVE FLAT FILTER SECTION, HOT WATER HEATING COIL SECTION, AND FAN SECTION.

FAN SECTION SHALL BE STACKED ON TOP OF COIL SECTION WITH UPBLAST FAN.

FAN ROTATION SHALL COUNTER CLOCKWISE WHEN VIEWING THE UNIT FROM THE LEFT SIDE (AIR BLOWING IN THE FACE).

COIL CONNECTIONS SHALL BE ON THE LEFT SIDE (AIR BLOWING IN THE FACE).

SHIP UNIT IN SECTIONS FOR FIELD ASSEMBLY.

GBEE

GREEN BUILDING ENERGY ENGINEERS, LLC MECHANICAL - ELECTRICAL - PLUMBING

8029 Somerville Lane FAX: 410-799-1081 It is a blessing to work with you. www.GreenBuildingEnergyEngineers.com

SUBCONSULTANT

Columbia Engineering, Inc. 6210 Old Dobbin Lane, Suite 150 Columbia, MD 21045

SEAL

Professional Certification. I certify that these documents were prepared or approved by me, and that I am a duly licensed engineer under the laws of the State of Maryland, License Number 20533, expiration date 8/5/2016.


OWNER

Howard County Public School System 8045 Harriet Tubman Lane Columbia, MD 21044

PROJECT

FENNIAL DOMEST EN MAKE

KEY PLAN

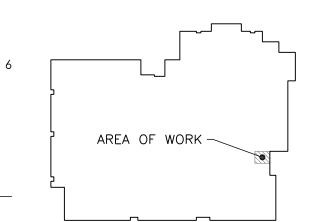



01	CONSTRUCTION DOCUMENTS	07/14/14
N O.	DESCRIPTION	DATE

DRAWING

KITCHEN MAKE-UP AIR UNIT DEMO & NEW WORK PLANS, DETAILS, AND SCHEDULES

Ι.		
8	DRAWN BY	WLA
	CHECKED BY	WLA
	PROJECT NO.	14014
	SCALE	AS SHOWN

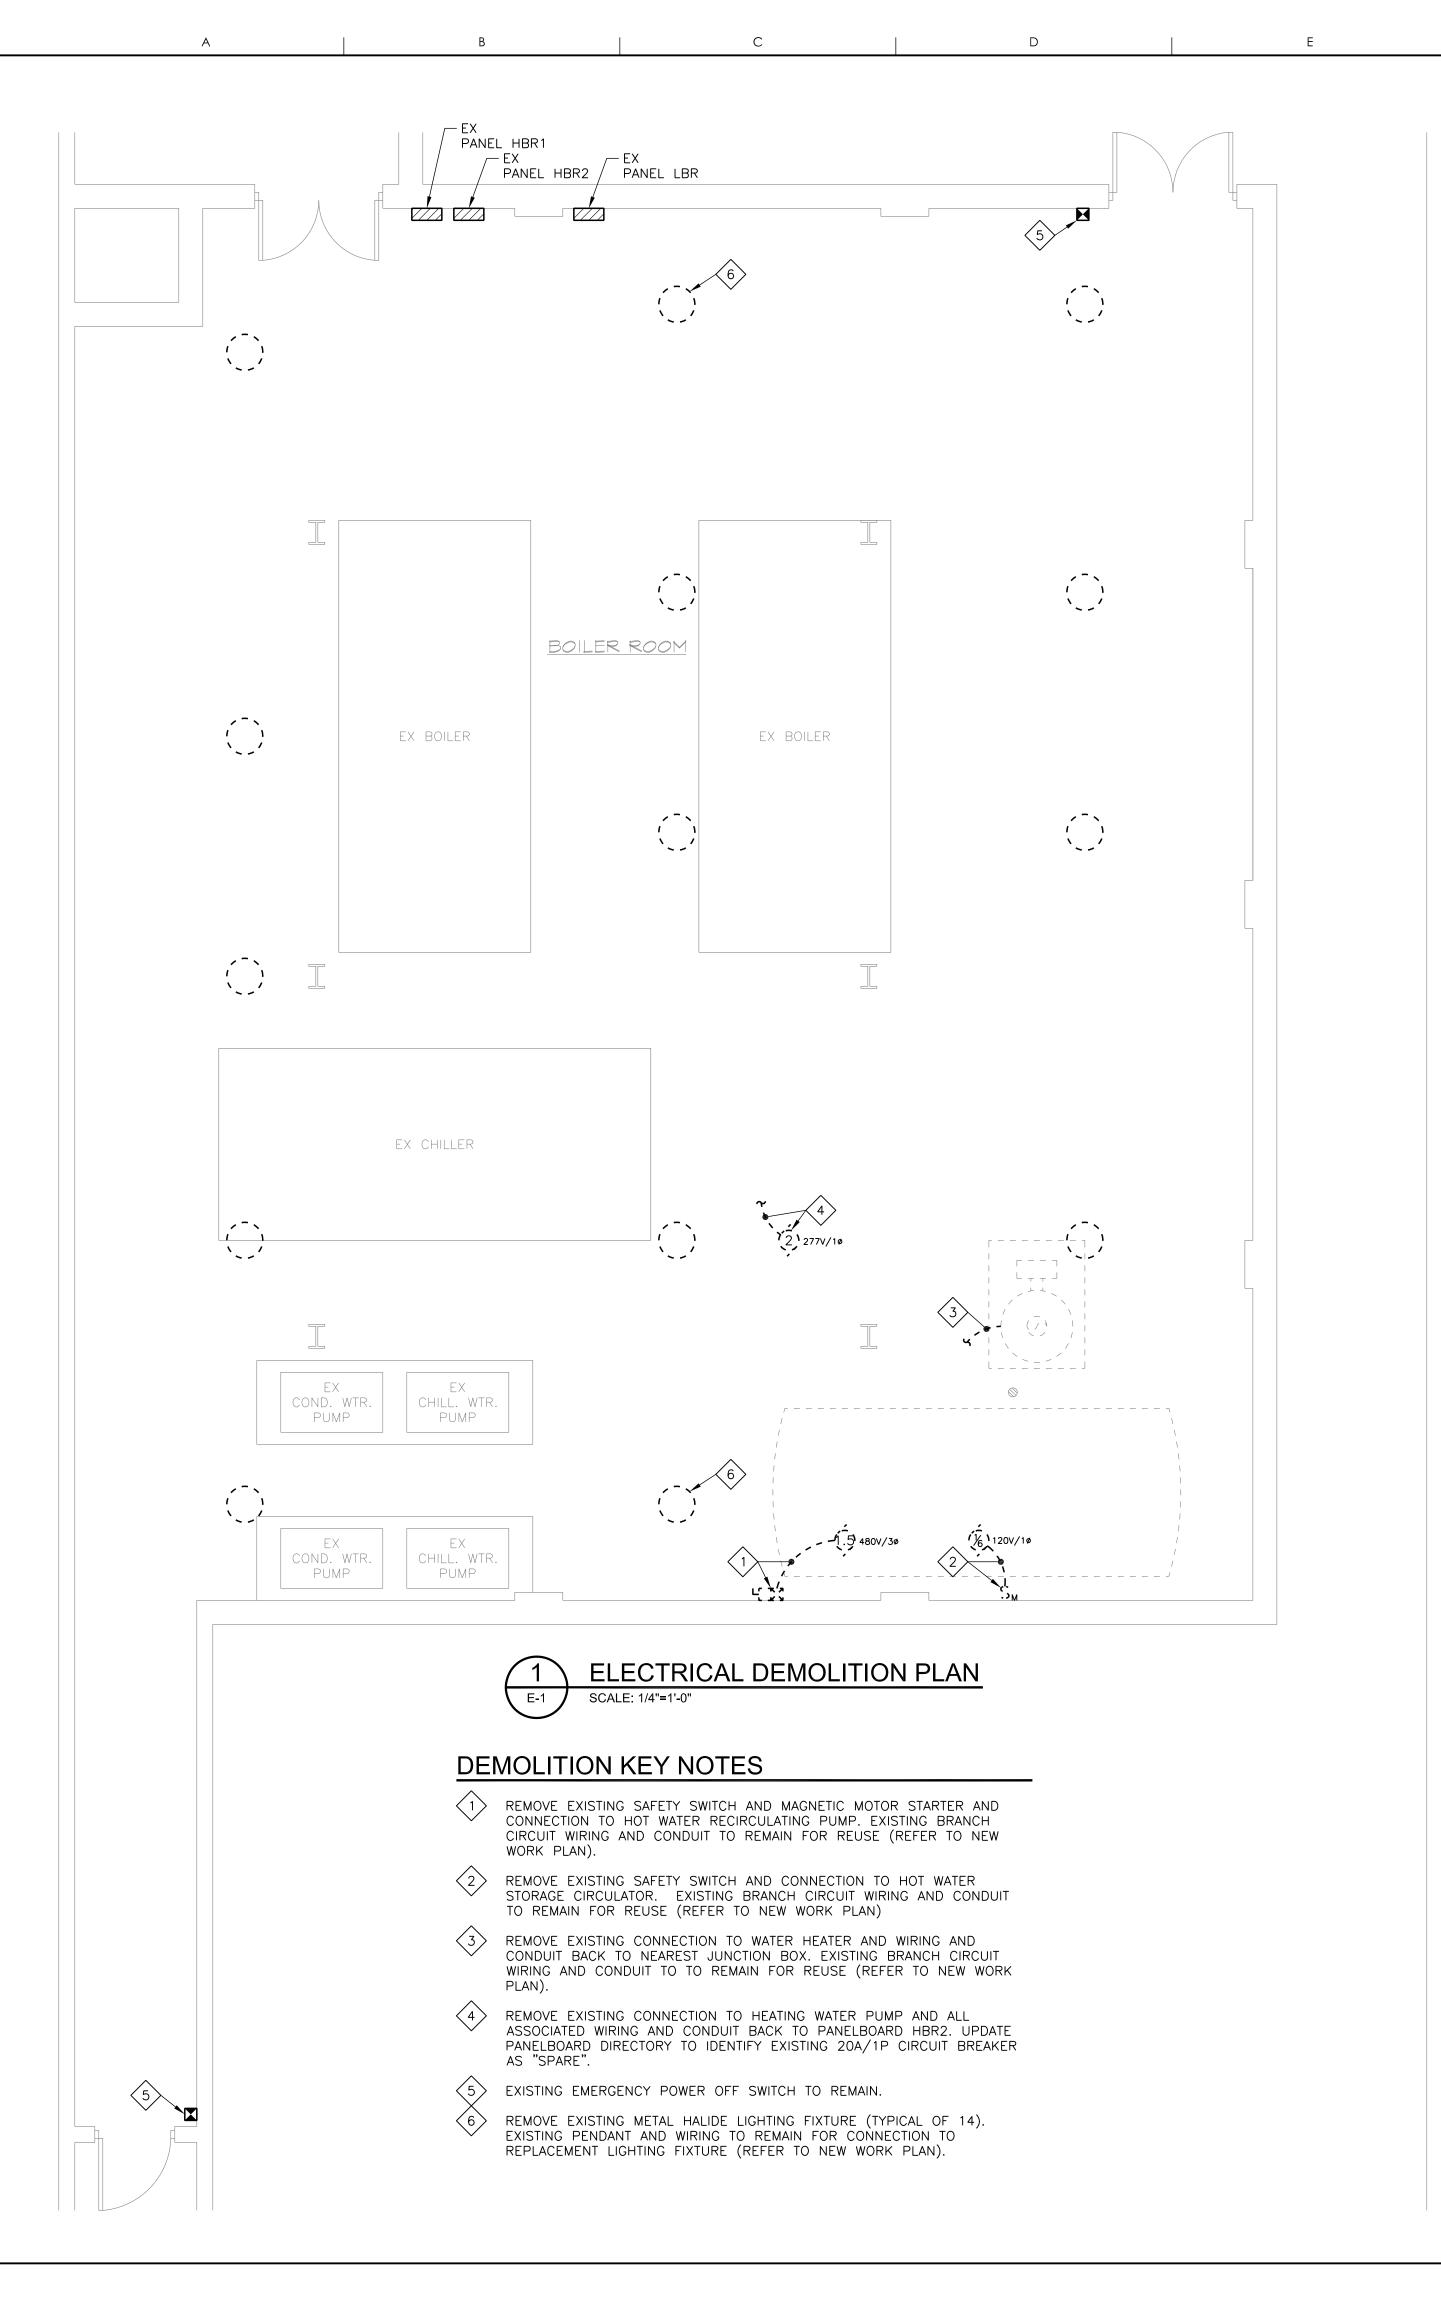

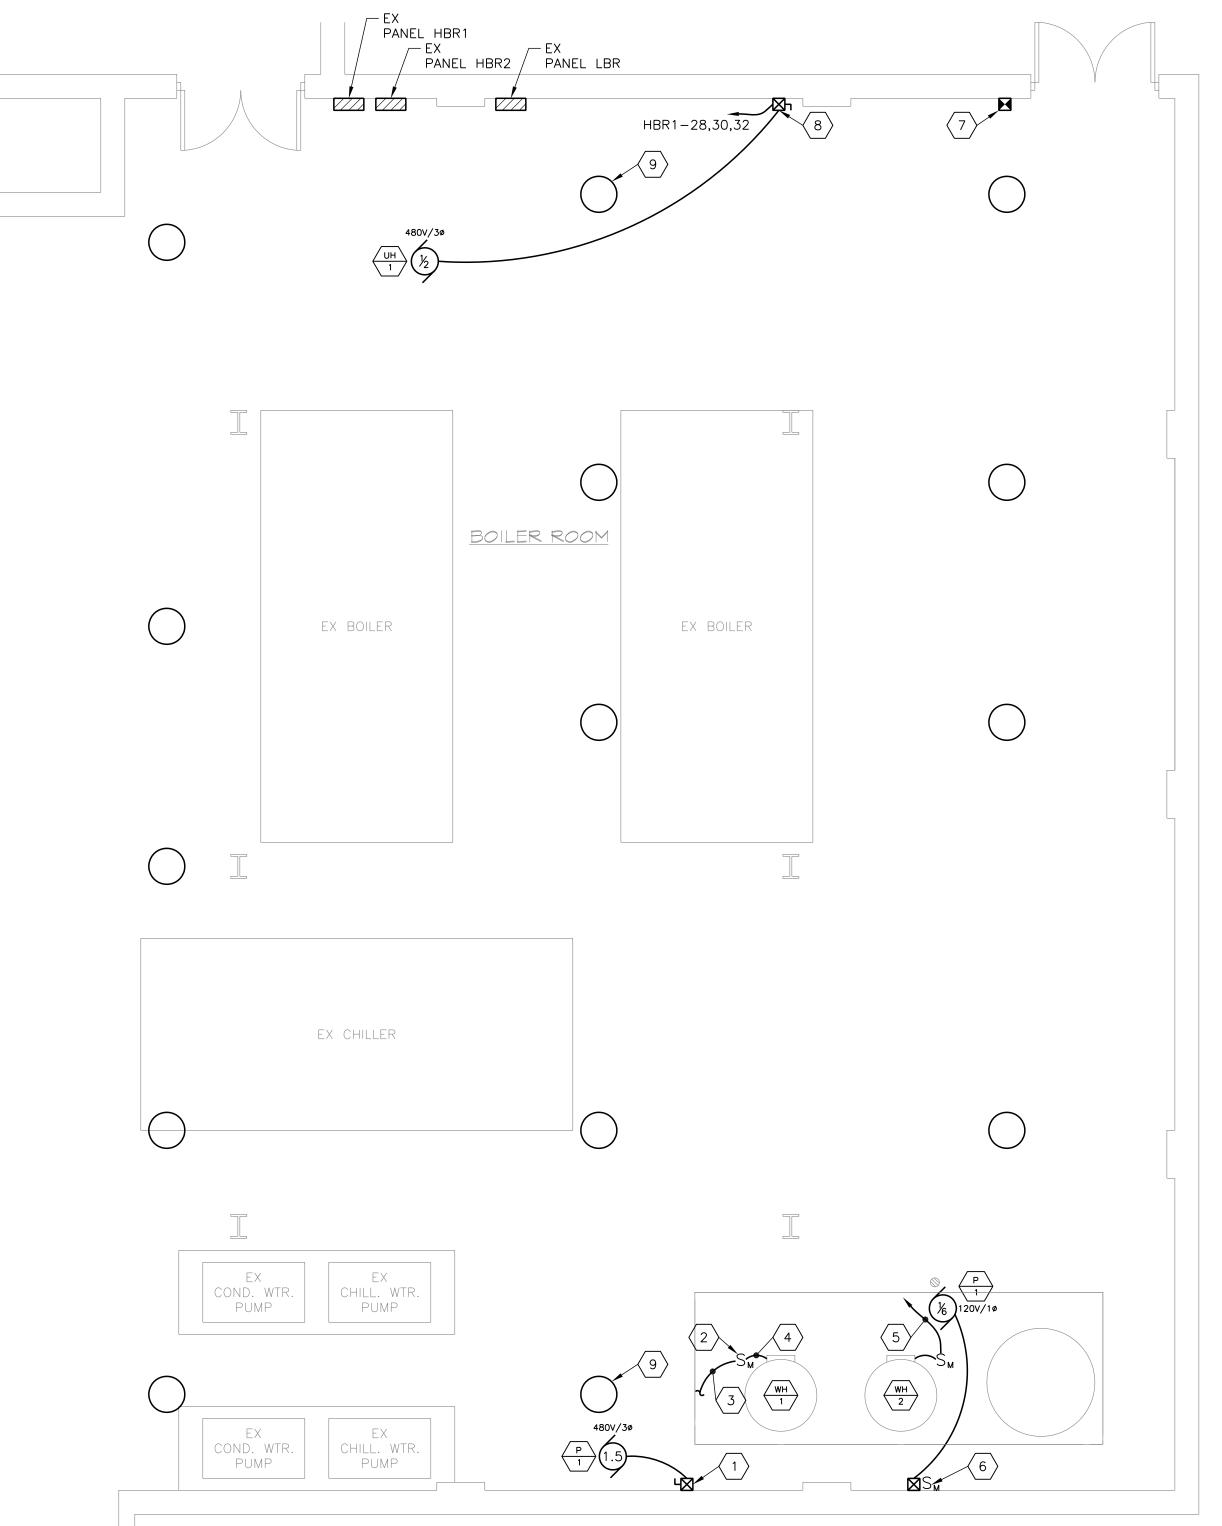



NEW WORK KEY NOTES

- 3P, 600V COMBINATION MAGNETIC MOTOR STARTER WITH NON-FUSED SAFETY SWITCH, NEMA SIZE 0 STARTER, AND H AND/OFF/AUTO SWITCH IN NEMA 1 ENCLOSURE. CONNECT TO EXISTING BRANCH CIRCUIT WIRING. EXTEND 3#12 + #12 GROUND IN ¾" LIQUID TIGHT FLEXIBLE METAL CONDUIT AND MAKE CONNECTION TO PUMP P-1.
- 2 LOCKABLE 30A/2P, 240V MOTOR RATED SWITCH IN NEMA 1 ENCLOSURE. PROVIDE UNISTRUT FRAME TO MOUNT SAFETY SWITCH NEAR WATER HEATER (TYPICAL
- CONNECT 2#12 + #12 GROUND IN 34" CONDUIT TO EXISTING BRANCH CIRCUIT WIRING THAT WAS DISCONNECTED UNDER DEMOLITION.
- EXTEND 2#12 + #12 GROUND IN ¾" LIQUID TIGHT FLEXIBLE METAL CONDUIT AND MAKE CONNECTION TO WATER HEATER (TYPICAL OF 2).
 - EXTEND 2#12 + #12 GROUND IN ¾" CONDUIT TO PANEL LBR AND PROVIDE 20A/1P SHUNT TRIP CIRCUIT BREAKER TO MATCH EXISTING EQUIPMENT. UPDATE PANELBOARD DIRECTORY.

NEW WORK KEY NOTES (CONT.)

- 30A/2P, 240V MOTOR RATED SWITCH AND SIZE 0 MAGNETIC MOTOR STARTER WITH HAND/OFF/AUTO SWITCH IN NEMA 1 ENCLOSURES. CONNECT TO EXISTING BRANCH CIRCUIT WIRING. EXTEND 2#12 + #12 GROUND IN 3/4" CONDUIT AND MAKE CONNECTION TO PUMP P-2
- PROVIDE ALL WIRING AND CONDUIT NECESSARY TO ADD EMERGENCY POWER SHUT OFF OF WATER HEATER WH-2 THROUGH THE SHUNT TRIP CIRCUIT BREAKER PROTECTING THE WATER HEATER CIRCUIT WHEN THE EMERGENCY POWER OFF SWITCH IS DEPRESSED.
- 3P, 600V COMBINATION MAGNETIC MOTOR STARTER WITH NON-FUSED SAFETY SWITCH, NEMA SIZE 0 STARTER, AND HAND/O FF/AUTO SWITCH IN NEMA 1 ENCLOSURE. EXTEND 3#12 + #12 GROUND IN 34" CONDUIT TO UNIT HEATER UH-1 AND TO PANEL HBR1. CONNECT TO EXISTING SPARE CIRCUIT BREAKER IN PANEL
- PROVIDE REPLACEMENT LED HIGH BAY LIGHTING FIXTURE, 78W, 4000K COLOR TEMPERATURE, EQUAL TO BAYLED78NW. CONNECT TO EXISTING PENDANT AND 277V/10 WIRING.





GREEN BUILDING ENERGY ENGINEERS, LLC

SUBCONSULTANT

Columbia Engineering, Inc. 6210 Old Dobbin Lane, Suite 150

It is a blessing to work with you. www.GreenBuildingEnergyEngineers.com

Columbia, MD 21045

SEAL

Professional Certification. I certify that these documents were prepared or approved by me, and that I am a duly licensed engineer under the laws of the State of Maryland, License

Number 20533, expiration date 8/5/2016.

OWNER

Howard County Public School System 8045 Harriet Tubman Lane Columbia, MD 21044

PROJECT


High School

R HEATER AND
UNIT REPLACEME

al High School

entennial Hi O Centennial Lane ott City, MD 21042

TENNIAI DOMES EN MAK

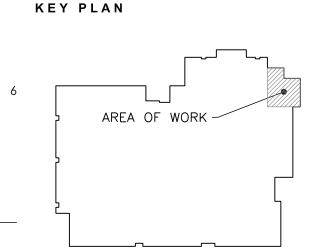


	N O.	DESCRIPTION	DATE
	01	CONSTRUCTION DOCUMENTS	07/14/14
/			
7			

DRAWING

CHS DOMESTIC HOT WATER ELECTRICAL DEMOLITION AND NEW WORK PLANS

	DRAWN BY	WLA
8	CHECKED BY	WLA
	PROJECT NO.	14014
	SCALE	as shown
	SHEET	

E-

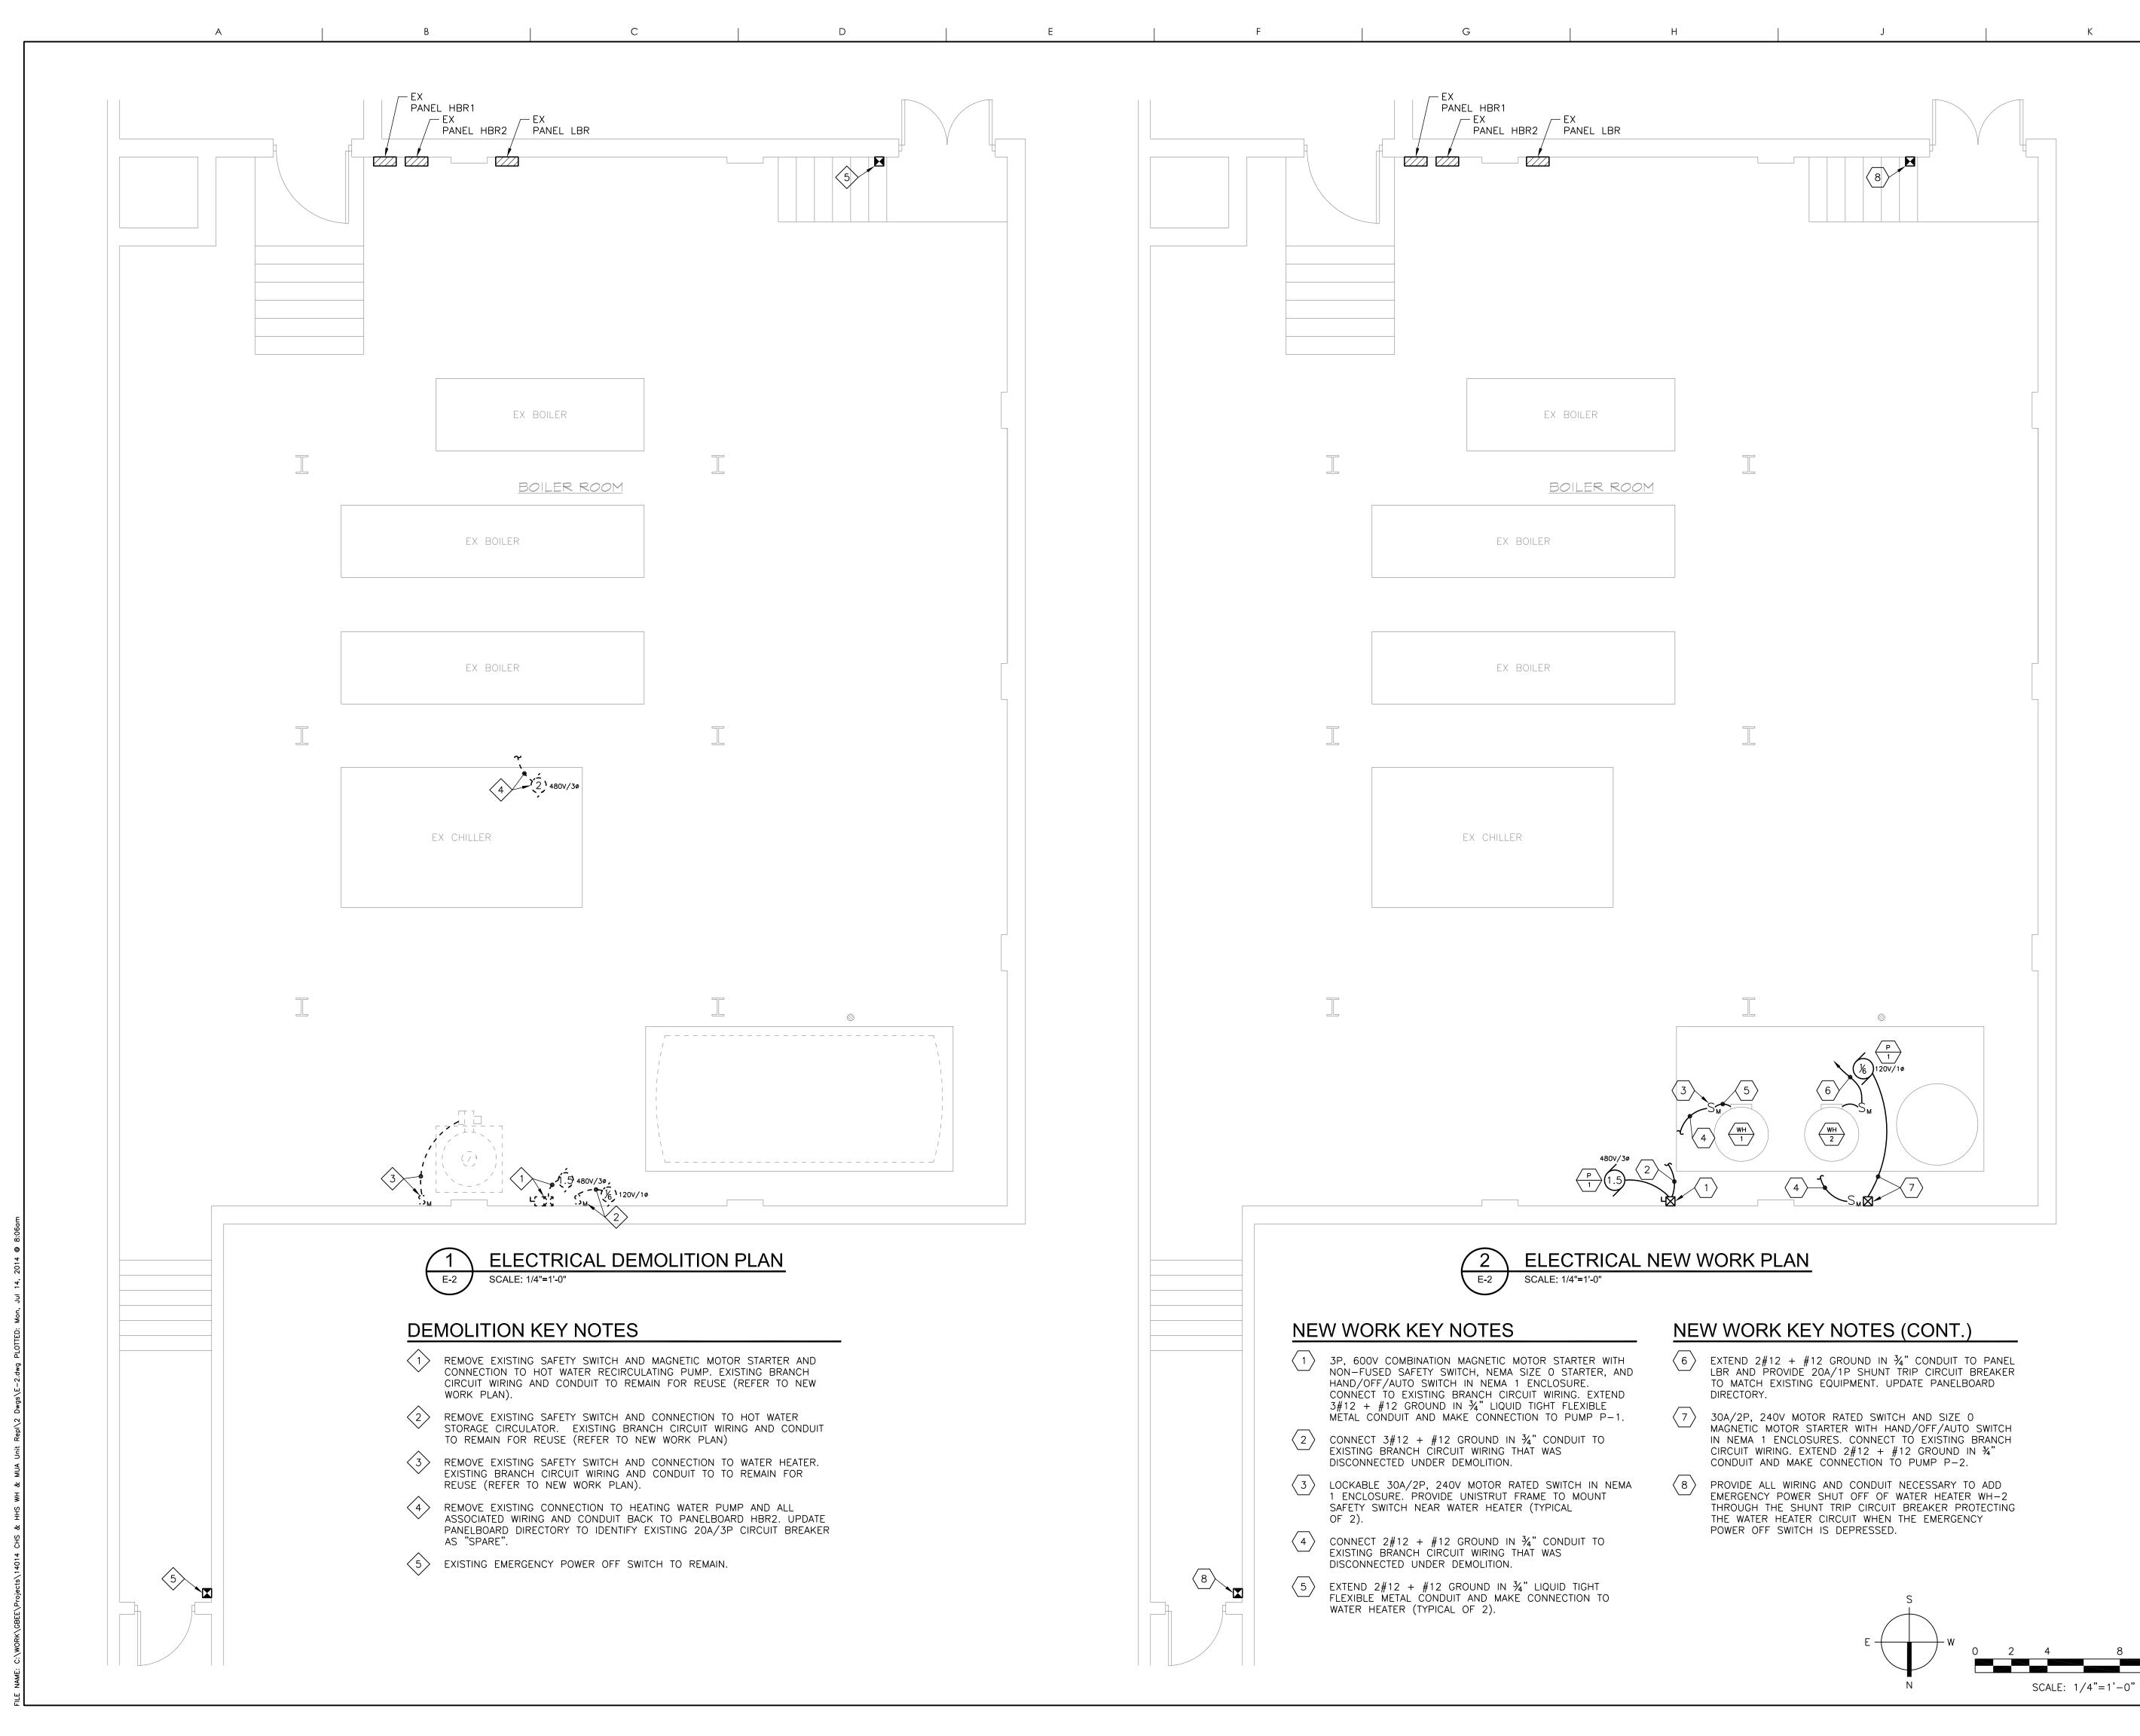



GREEN BUILDING ENERGY ENGINEERS, LLC

MECHANICAL - ELECTRICAL - PLUMBING

8029 Somerville Lane
Elkridge, MD 21075
It is a blessing to work with you.

TEL: 410-799-1080
FAX: 410-799-1081
www.GreenBuildingEnergyEngineers.com

SUBCONSULTANT

Columbia Engineering, Inc. 6210 Old Dobbin Lane, Suite 150 Columbia, MD 21045

SEAL

Professional Certification. I certify that these documents were prepared or approved by me, and that I am a duly licensed engineer under the laws of the State of Maryland, License

Number 20533, expiration date 8/5/2016.

OWNER


Howard County Public School System 8045 Harriet Tubman Lane Columbia, MD 21044

PROJECT

ligh School 8800 Guilford Road Columbia, MD 21046

ER HEATER AND
UNIT REPLACEMEN

nial High School Llane 21042

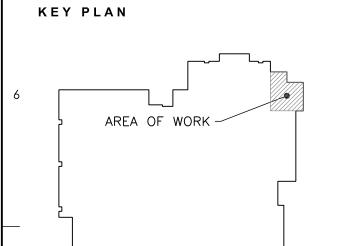

01	CONSTRUCTION DOCUMENTS	07/14/14
N O.	DESCRIPTION	DATE


DRAWING

HHS DOMESTIC HOT WATER ELECTRICAL DEMOLITION AND NEW WORK PLANS

Ι.		
	DRAWN BY	WLA
8	CHECKED BY	WLA
	PROJECT NO.	14014
	SCALE	as shown
Ι.	SHEET	


E-2



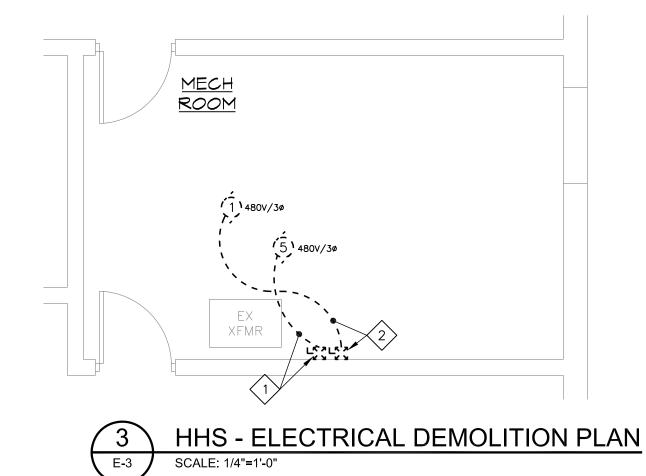


DEMOLITION KEY NOTES

- REMOVE EXISTING SAFETY SWITCH AND MAGNETIC MOTOR STARTER AND CONNECTION TO AIR HANDLING UNIT. EXISTING BRANCH CIRCUIT WIRING AND CONDUIT TO REMAIN FOR REUSE (REFER TO NEW WORK PLAN).
- REMOVE EXISTING SAFETY SWITCH AND MAGNETIC MOTOR STARTER AND CONNECTION TO HEATING WATER PUMP. EXISTING BRANCH CIRCUIT WIRING AND CONDUIT TO REMAIN FOR REUSE (REFER TO NEW WORK PLAN).

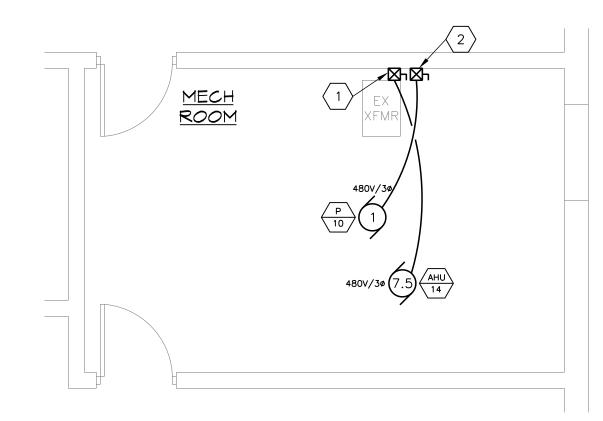

CHS - ELECTRICAL NEW WORK PLAN E-3 SCALE: 1/4"=1'-0"

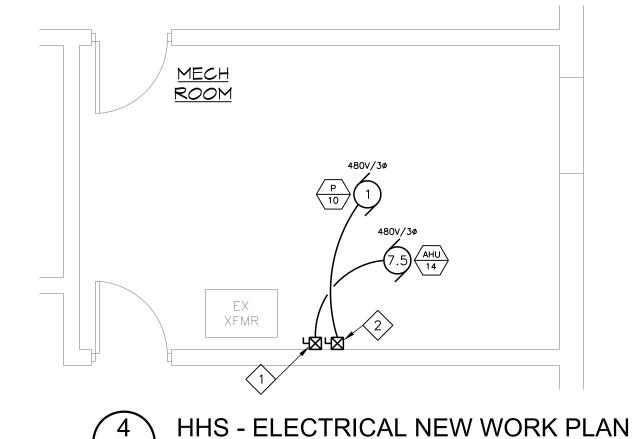


NEW WORK KEY NOTES

SCALE: 1/4"=1'-0"

- 3P, 600V COMBINATION MAGNETIC MOTOR STARTER WITH NON-FUSED SAFETY SWITCH, NEMA SIZE 1 STARTER, AND HAND/OFF/AUTO SWITCH IN NEMA 1 ENCLOSURE. CONNECT TO EXISTING BRANCH CIRCUIT WIRING. EXTEND 3#12 + #12 GROUND IN 34" CONDUIT AND MAKE CONNECTION TO AIR HANDLING UNIT AHU-14.
- 3P, 600V COMBINATION MAGNETIC MOTOR STARTER WITH NON-FUSED SAFETY SWITCH, NEMA SIZE O STARTER, AND HAND/OFF/AUTO SWITCH IN NEMA 1 ENCLOSURE. CONNECT TO EXISTING BRANCH CIRCUIT WIRING. EXTEND 3#12 + #12 GROUND IN 34" CONDUIT AND MAKE CONNECTION TO

ADD ALTERNATE PRICING

1. THE PRICE FOR ALL WORK ASSOCIATED WITH THE REPLACEMENT OF THE KITCHEN MAKE-UP AIR UNIT FOR EACH SCHOOL SHOWN ON DRAWINGS M-1 AND E-3 SHALL BE IDENTIFIED ON THE BID FORM AS THE ADD ALTERNATE NO. 1 PRICE FOR EACH SCHOOL.

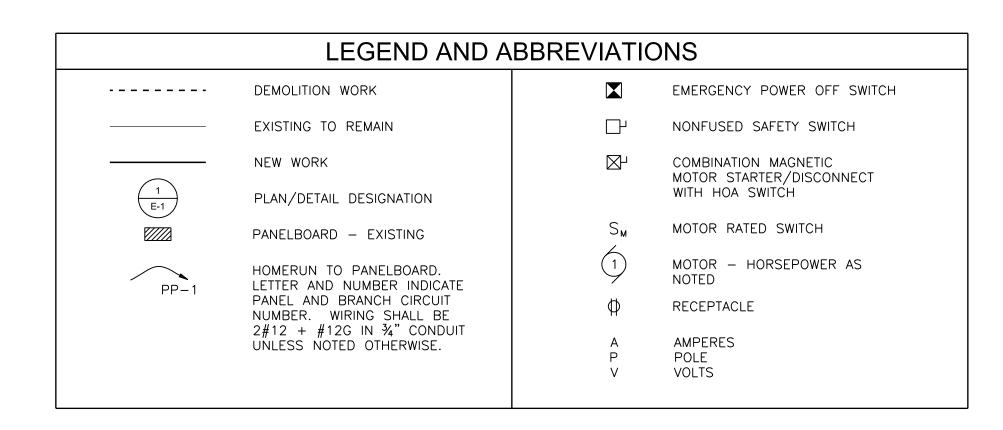



GREEN BUILDING ENERGY ENGINEERS, LLC

MECHANICAL - ELECTRICAL - PLUMBING 8029 Somerville Lane TEL: 410-799-1080 FAX: 410-799-1081 It is a blessing to work with you. www.GreenBuildingEnergyEngineers.com

SUBCONSULTANT

Columbia Engineering, Inc. 6210 Old Dobbin Lane, Suite 150 Columbia, MD 21045

SEAL

Professional Certification. I certify that these documents were prepared or approved by me, and that I am a duly licensed engineer under the laws of the State of Maryland, License Number 20533, expiration date 8/5/2016.

OWNER

Howard County Public School System 8045 Harriet Tubman Lane Columbia, MD 21044

PROJECT

CENTENNIAL & H
DOMESTIC \

KEY PLAN AREA OF WORK -

01 CONSTRUCTION DOCUMENTS 07/14/14 NO. DESCRIPTION DATE

DRAWING

KITCHEN MAKE-UP AIR UNIT DEMO & NEW WORK PLANS

	DRAWN BY	WLA
8	CHECKED BY	WLA
	PROJECT NO.	14014
'	SCALE	as shown
'	SHEET	

GENERAL NOTES

METAL DECK:

ROOF DECK SHALL BE MADE OF STEEL CONFORMING TO ASTM A653 SS GRADE 33. GALVANIZED DECK SHALL HAVE COATING DESIGNATION G60.

METAL DECK SHALL HAVE THE FOLLOWING MINIMUM SECTION PROPERTIES: •ROOF DECK ------ I = 0.155 in⁴ ,S = 0.186 in³

ALL METAL DECK HAS BEEN DESIGNED TO BE CONTINUOUS OVER 3 SPANS MINIMUM AND SHALL BEAR AT LEAST 2" ON STEEL SUPPORTS. FOR ONE OR TWO SPAN CONDITIONS, THE CONTRACTOR SHALL PROVIDE SHORING OR FURNISH HEAVIER GAGE DECK AS REQUIRED TO SUPPORT ALL THE APPLICABLE LOADS. THE CONTRACTOR SHALL SUBMIT THE ALTERNATE LAYOUT FOR APPROVAL.

DECK SHALL BE ATTACHED TO SUPPORTING STEEL AT ENDS AS NOTED ON

EXISTING CONSTRUCTION:

COLUMBIA ENGINEERING INC. HAS PREPARED THESE PLANS BASED ON A LIMITED AMOUNT OF FIELD EXPLORATION AND ON THE STRUCTURAL INFORMATION SHOWN IN DRAWING S-10 PREPARED BY DUNCAN GRAY STRUCTURAL ENGINEER DATED MAY 1975. THE EXISTING MEMBER SIZES ARE NOTED (E) AND ARE SHOWN IN THE PLANS. THE CONTRACTOR SHALL VERIFY THAT THE EXISTING MEMBERS SHOWN IN THE PLANS MATCH EXISTING AS BUILT CONDITIONS. IF THE AS BUILT CONDITIONS DO NOT CONFORM TO THE INFORMATION SHOWN IN THE PLANS, OR IF ANY STRUCTURAL MEMBER IS FOUND TO BE IN POOR CONDITION, THE CONTRACTOR SHALL INFORM COLUMBIA ENGINEERING INC. OF THE ACTUAL SIZES AND/OR CONDITION. RE-DESIGN AND ADDITIONAL FRAMING MAY BE REQUIRED IN THAT CASE.

ALL NEW PENETRATIONS THROUGH THE EXISTING ROOFS SHALL BE ACCURATELY LOCATED BY THE CONTRACTOR. THE CONTRACTOR SHALL PREPARE SHOP DRAWINGS SHOWING ALL PROPOSED OPENINGS AND SHALL SUBMIT THESE FOR REVIEW AND APPROVAL PRIOR TO CUTTING ANY OPENINGS.

NEW PENETRATIONS SHOWN IN THE STRUCTURAL DRAWINGS ARE PRINCIPAL OPENINGS. THE CONTRACTOR SHALL COORDINATE WITH THE ARCHITECTURAL, MEP AND TELECOMMUNICATION DRAWINGS FOR ALL PENETRATIONS.

NOTE: 4

ALL NEW PIPE SHALL BE LOCATED BY THE CONTRACTOR TO AVOID SUPPORTING MEMBERS UNDER THE ROOF. THE CONTRACTOR SHALL NOT CUT ANY MEMBER WITHOUT THE PRIOR APPROVAL OF COLUMBIA ENGINEERING, INC.

NEW PENETRATION THROUGH THE ROOF DECK SHALL BE CORE DRILLED.

MISCELLANEOUS:

THE CONTRACTOR SHALL NOTIFY THE ARCHITECT AND STRUCTURAL ENGINEER OF ANY DISCREPANCIES BETWEEN THE STRUCTURAL DOCUMENTS AND ANY OTHER DOCUMENTS OR EXISTING CONDITIONS FOR RESOLUTION PRIOR TO PROCEEDING WITH FABRICATION OR CONSTRUCTION.

SHOP DRAWINGS FOR ALL STRUCTURAL ITEMS MUST BE SUBMITTED BY THE CONTRACTOR. IF A CONTRACTOR OR OWNER FAILS TO SUBMIT THE SHOP DRAWINGS, THE FIRM COLUMBIA ENGINEERING, INC., WILL NOT BE RESPONSIBLE FOR THE STRUCTURAL CERTIFICATION AND/OR THE DESIGN OF THE PROJECT.

DESIGN CODES:


1. INTERNATIONAL BUILDING CODE: 2012

DESIGN LOADS:

1. LIVE LOAD ----- 30 PSF

2. GROUND SNOW LOAD, pg ----- 30 PSF 3. FLAT ROOF SNOW LOAD, pf ---- 23 PSF 4. SNOW EXPOSURE FACTOR, Ce ---- 1.0

5. SNOW LOAD IMPORTANCE FACTOR, Is ---- 1.1 6. THERMAL FACTOR, Ct -----1.0

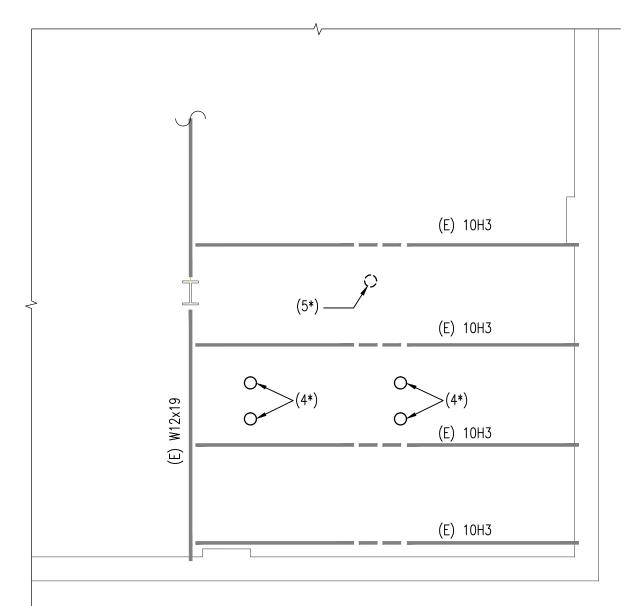


CHS -PARTIAL EXISTING ROOF PLAN -NEW WORK

SCALE: 1/4"=1'-0"

NOTES:


- 1.) (E) DENOTES EXISTING.
- 2.) ALL NEW CONSTRUCTION SHOWN BOLD.
- 3.) EXISTING ROOF DECK IS 1 1/2", 22 GAGE METAL DECK.
- 4.) (4*) DENOTES NEW 6" DIAMETER HOLE. ACCURATELY LOCATE THE HOLE AND CAREFULLY CORE
- DRILL THROUGH THE METAL DECK. 5.) (5*) DENOTES EXISTING HOLE TO BE INFILLED. SEE DETAIL A/S-1 OR B/S-1.
- 6.) SEE MECHANICAL DRAWINGS FOR CURB.

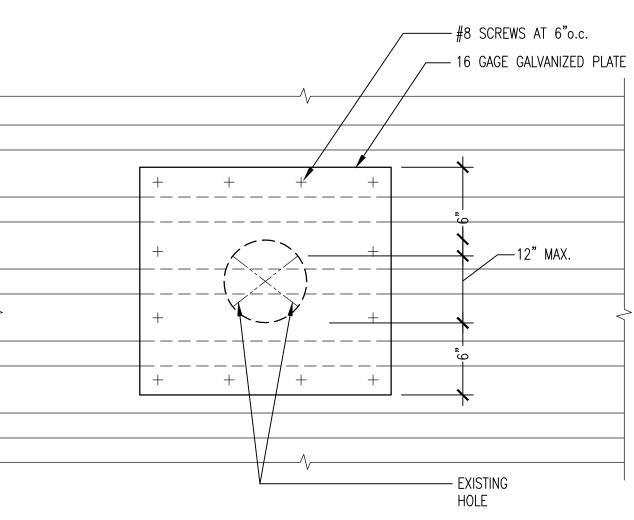


SCALE: 1 1/2"=1'-0"

1.) IF HOLE DIAMETER EXCEEDS 12", INFILL PER B/S-1.

DECK PATCH DETAIL

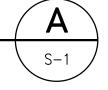

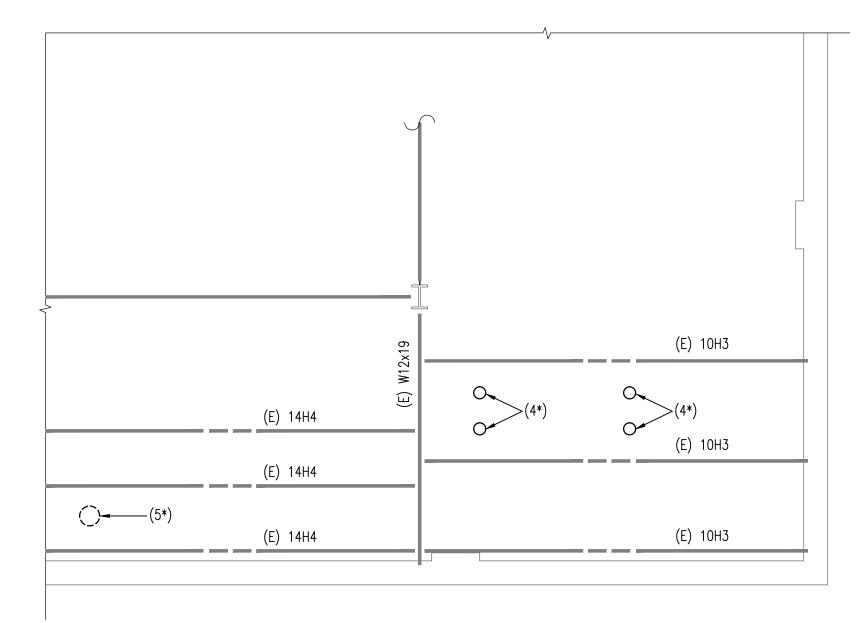


HHS -PARTIAL EXISTING ROOF PLAN -**NEW WORK**

SCALE: 1/4"=1'-0"

NOTES:

- 1.) (E) DENOTES EXISTING.
- 2.) ALL NEW CONSTRUCTION SHOWN BOLD.
- 3.) EXISTING ROOF DECK IS 1 1/2", 22 GAGE METAL DECK.
- 4.) (4*) DENOTES NEW 6" DIAMETER HOLE. ACCURATELY LOCATE THE HOLE AND CAREFULLY CORE DRILL THROUGH THE METAL DECK.
- 5.) (5*) DENOTES EXISTING HOLE TO BE INFILLED.
- SEE DETAIL A/S-1 OR B/S-1. 6.) SEE MECHANICAL DRAWINGS FOR CURB.



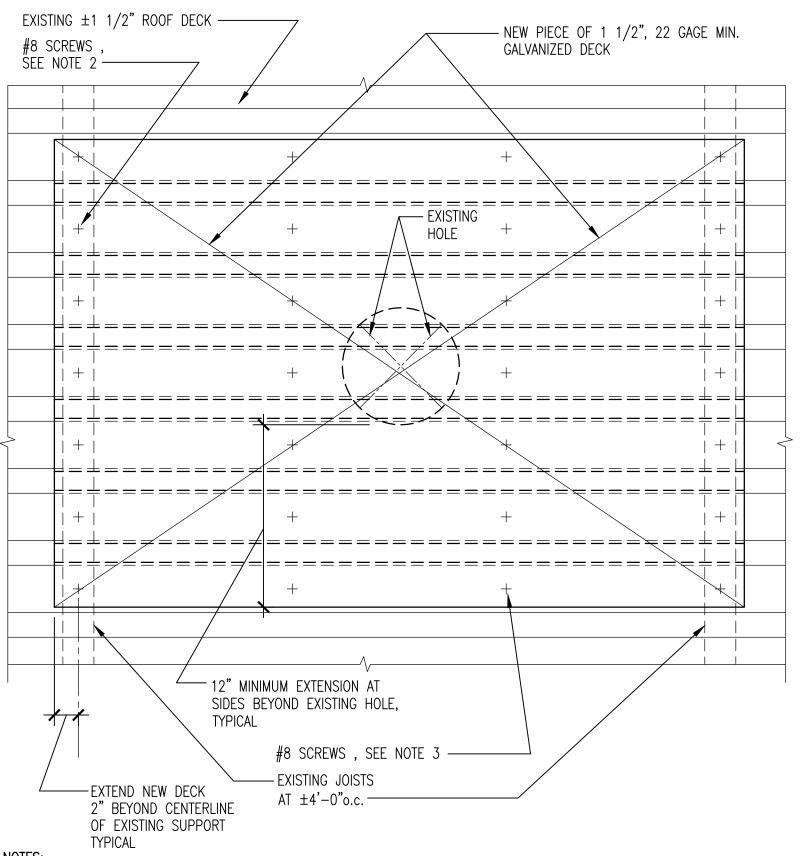

1.) ADD NEW SECTION OF DECK AS SHOWN OVER THE EXISTING HOLE.

2.) SCREW NEW DECK TO EXISTING SUPPORTS AT 6"o.c.

3.) SCREW NEW DECK TO EXISTING DECK AT 18"o.c. MAX.

DECK PATCH DETAIL

SCALE: $1 \frac{1}{2} = 1' - 0''$



GBEE

Green Building Energy Engineers, LLC Mechanical — Electrical — Plumbing

It is a blessing to work with you. www.GreenBuildingEnergyEngineers.com

Columbia Engineering, Inc.

6210 Old Dobbin Lane, Suite 150

Columbia, MD 21045

I hereby certify that these documents were prepared or approved by me, and that I am a duly licensed

professional engineer under the laws of the State of

Maryland, License No. 14479, Expiration Date: 06-22-2015.

Howard County Public School System

8045 Harriet Tubman Lane

Columbia, MD 21044

DOI KITCHEN I

AREA OF WORK -

CONSTRUCTION DOCUMENTS

CHS/HHS PARTIAL

ROOF PLANS, **GENERAL NOTES, AND**

DETAILS

NO. DESCRIPTION

DRAWING

DRAWN BY

CHECKED BY

PROJECT NO.

SCALE

B)

S-1

KEY PLAN

rchacon@columbiaengineering.com

Elkridge, MD 21075

OWNER

PROJECT

SUBCONSULTANT

Professional Certification.

TEL: 410-799-1080 FAX: 410-799-1081

CEI#14091

RC

AS SHOWN

14014

DATE